


Site Plans

Issued for	Bid
Date Issued	December 10, 2020
Latest Issue	January 19, 2021

South End Retrofits

Intersection of S. Prospect
Street and Prospect Parkway
City of Burlington, VT

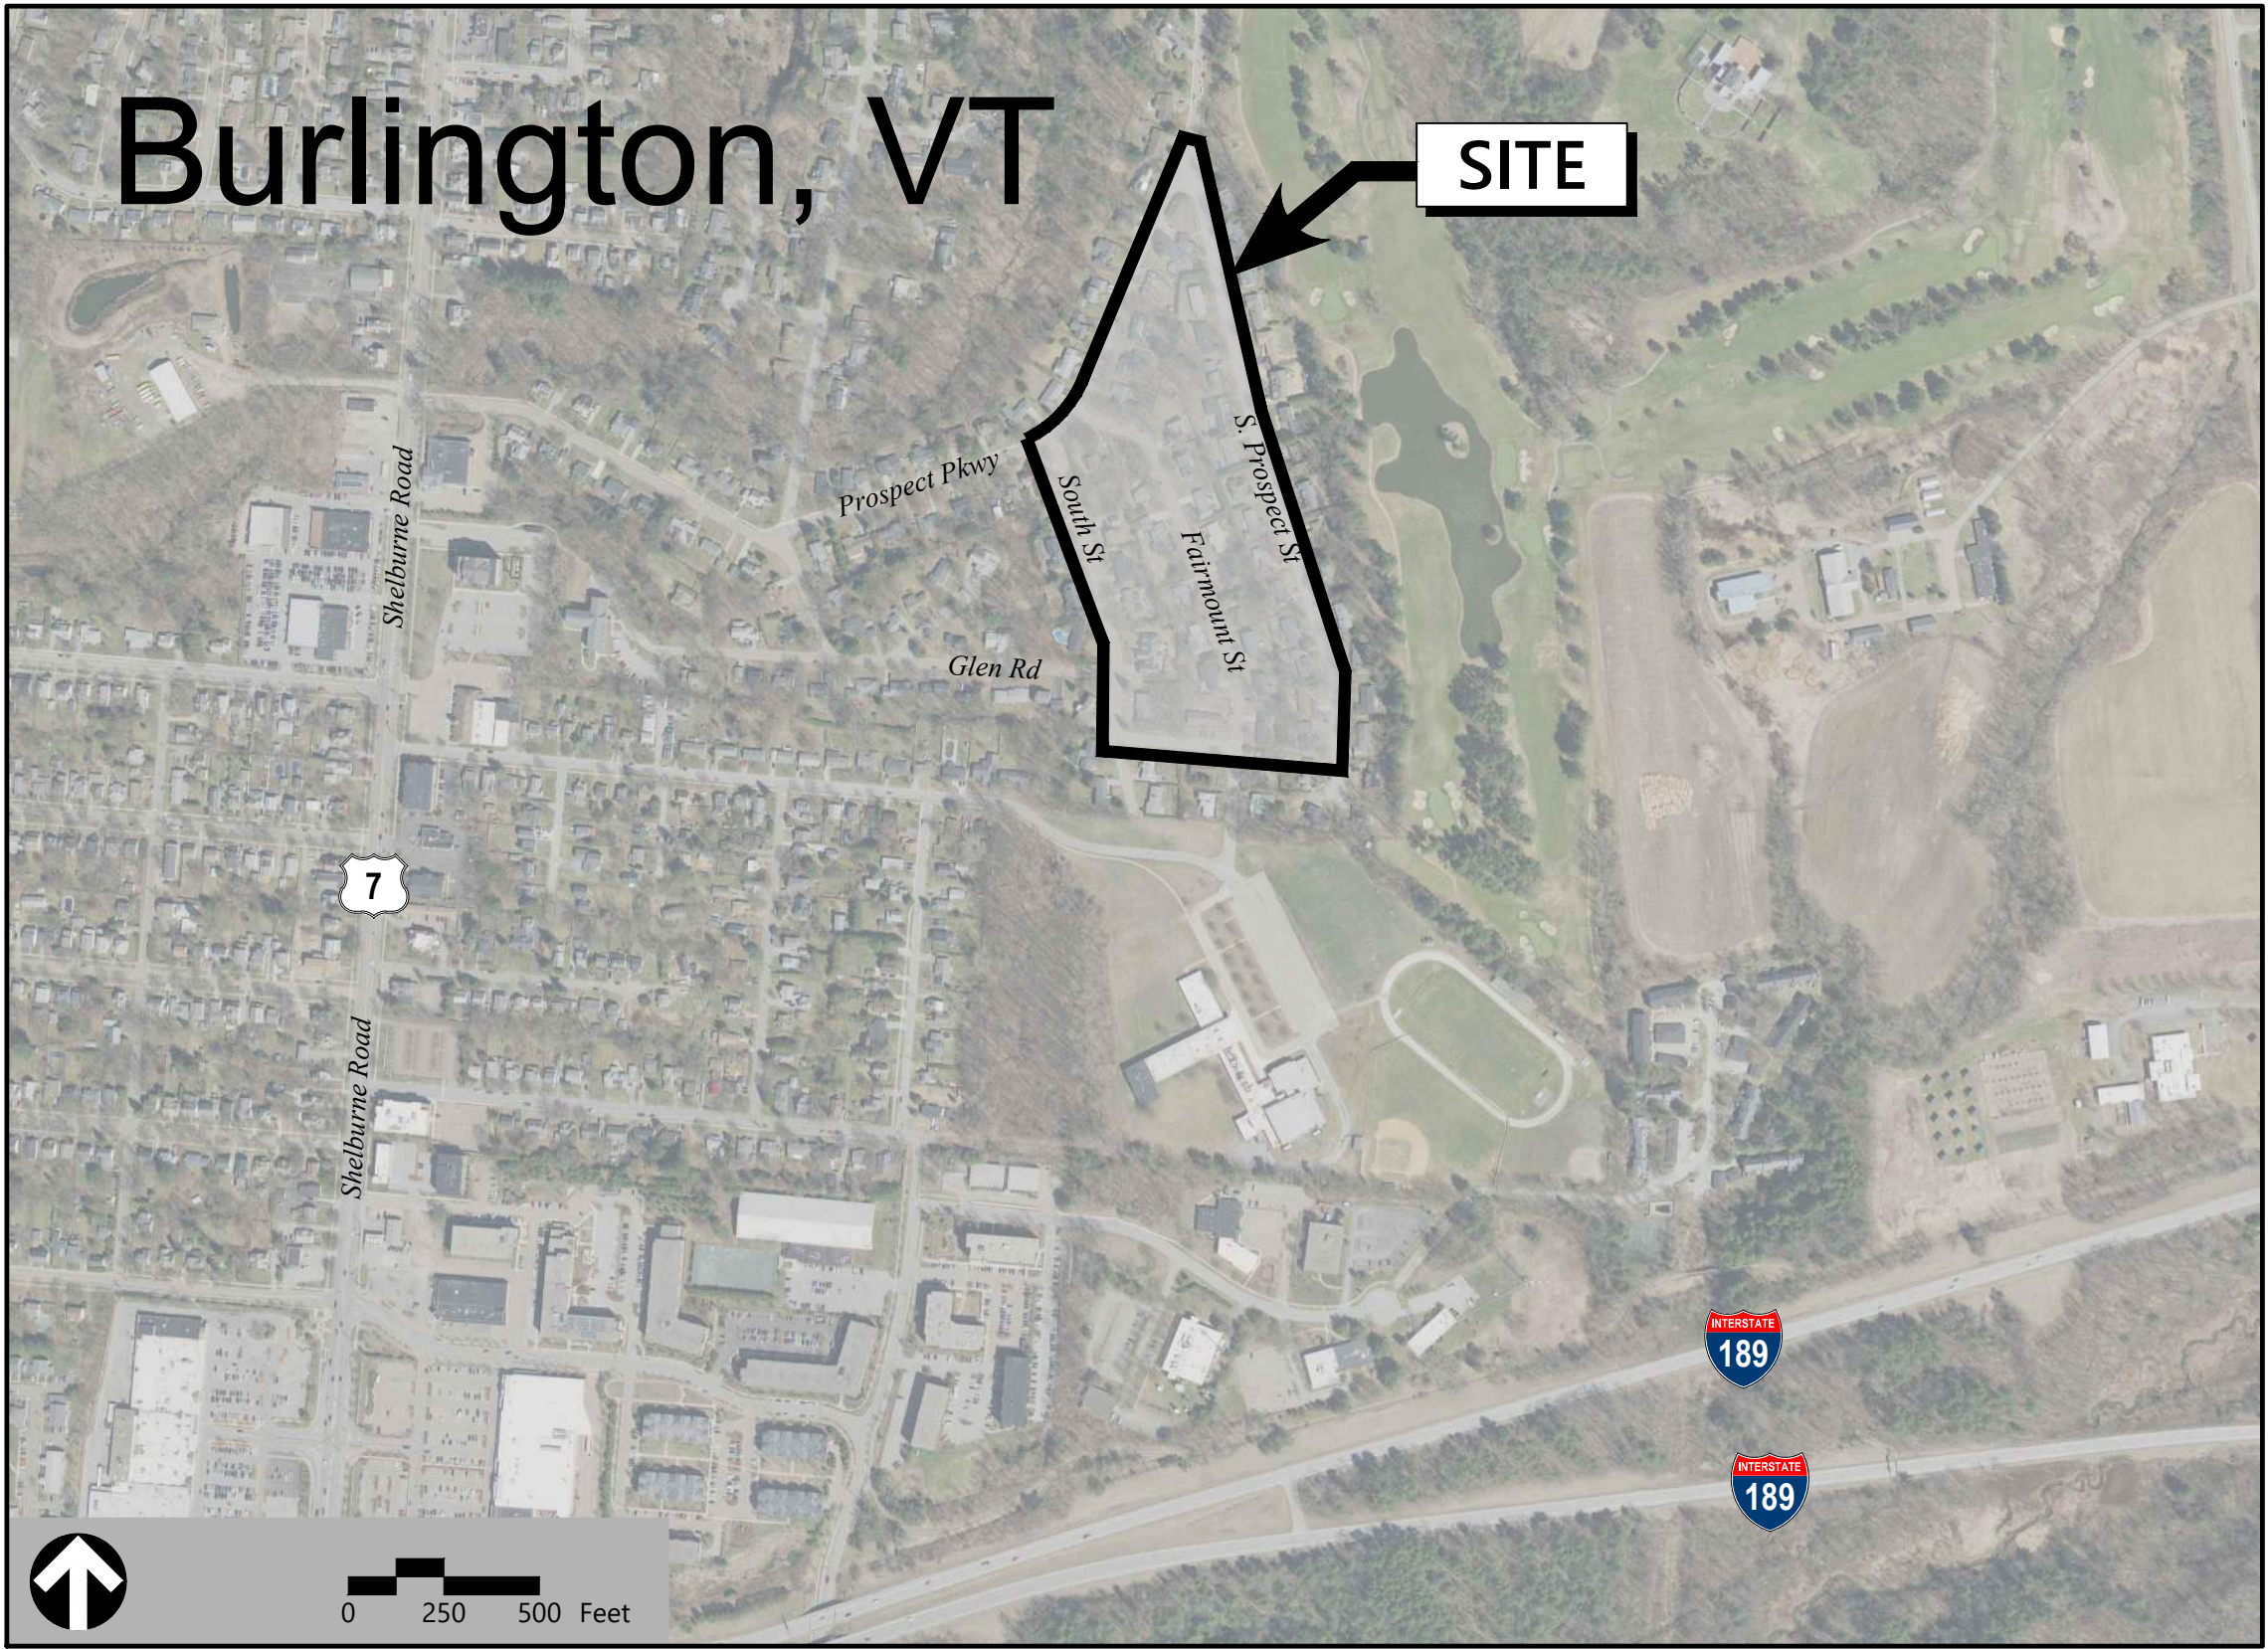



vhb.com

40 IDX Dr
Building 100 Suite 200
South Burlington, VT 05403
802.497.6100

Owner

City of Burlington
Department of Public Works
149 Church Street
Burlington, VT 05401


Applicant

VHB®
Nicholas Hadiaris, PE
40 IDX Drive
Building 100 Suite 200
South Burlington, VT 05403
802.497.6100

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No.	Drawing Title
C-0.01	Legend and General Notes
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C-1.01	Existing Conditions Plan
C-1.02	Existing Conditions Plan
C-1.03	Existing Conditions Plan
C-1.04	Existing Conditions Plan
C-2.01	Demolition and Erosion Control Plan
C-2.02	Demolition and Erosion Control Plan
C-2.03	Demolition and Erosion Control Plan
C-2.04	Demolition and Erosion Control Plan
C-3.00	Overall Layout and Materials Plan
C-3.01	Layout and Materials Plan
C-3.02	Layout and Materials Plan
C-3.03	Layout and Materials Plan
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L-1.01	Planting Plan
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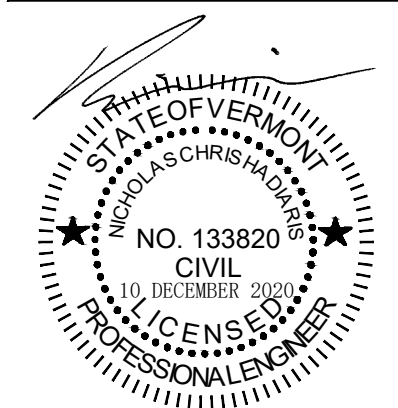


South End Retrofits
S. Prospect St. and Prospect Pky
Burlington, VT

No.	Revision	Date	Appvd.

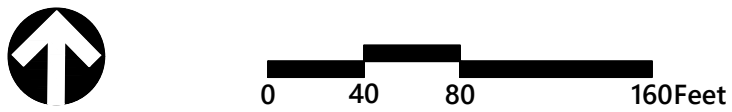Designed by	RWN	Checked by	NCH
Issued for	Bid	Date	Dec. 10, 2020

Overall Existing Conditions
Plan





Drawing Number

C-1.00

Sheet 3 of 24

Project Number
58126.01

- GENERAL SURVEY NOTES**
- THE PROPERTY LINES AND RIGHT-OF-WAY LINES ARE BASED ON STATE PARCEL MAPPING DATA AND ARE APPROXIMATE ONLY. THIS IS NOT A BOUNDARY SURVEY. THE TOPOGRAPHY AND PHYSICAL FEATURES SHOWN ARE BASED ON A FIELD SURVEY PERFORMED BY VHB IN APRIL 2019; OTHER FEATURES MAY EXIST THAT ARE NOT SHOWN HEREIN.
 - HORIZONTAL AND VERTICAL DATUMS ARE REFERENCED TO **VERMONT STATE PLANE GRID NAD 1983 (2011) AND NAVD88** BASED ON GPS OBSERVATIONS UTILIZING **VT CORS**.
 - BUILDING FOOTPRINTS WERE DOWNLOADED FROM THE VERMONT OPEN GEODATA PORTAL (VOGP). THE FOOTPRINTS WERE DERIVED FROM CIRCA 2016 HIGH RESOLUTION LIDAR AND 2016 ORTHOIMAGERY. THIS DATASET CONTAINS FOOTPRINTS FOR BUILDINGS AND SOME LARGE OUT BUILDINGS; SOME SMALLER STRUCTURES (E.G. SHEDS) MAY NOT BE INCLUDED.
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South End Retrofits
S. Prospect St. and Prospect Pky
Burlington, VT
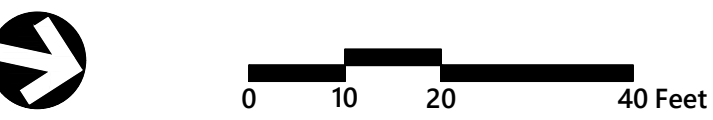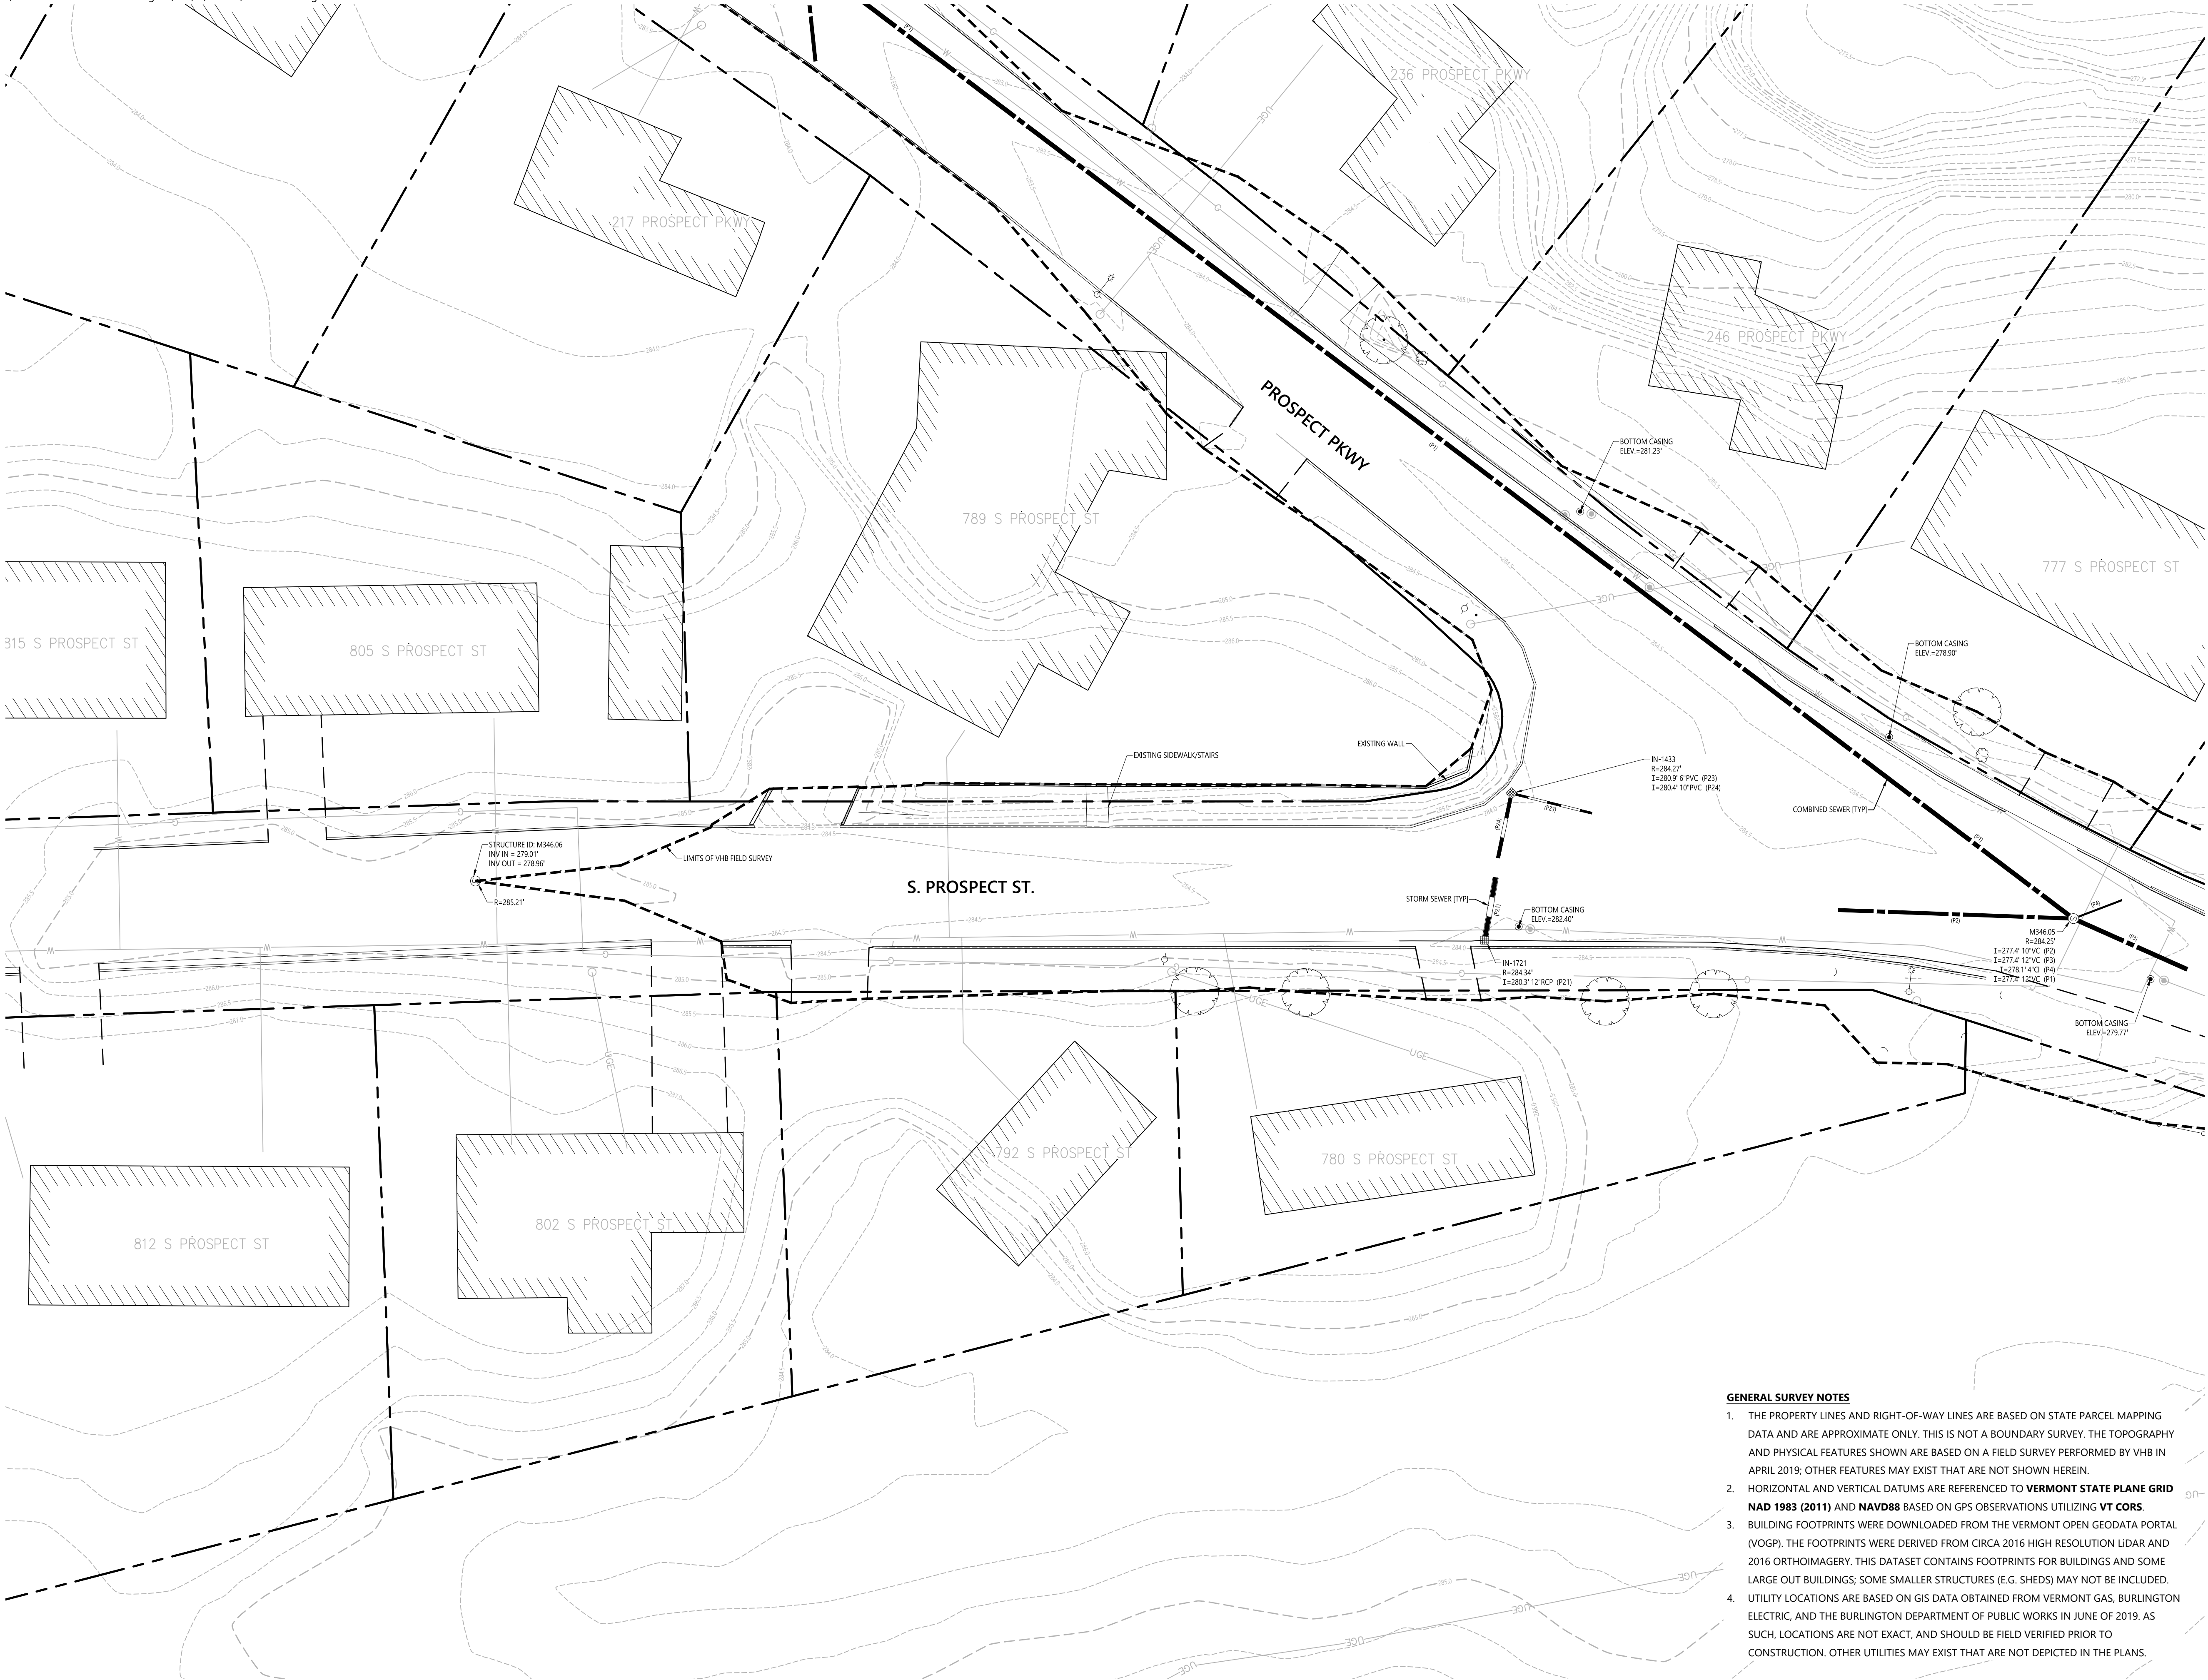
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Drawing Title

Existing Conditions Plan

Drawing Number

C-1.01


Sheet 4 of 24

Project Number

58126.01

Professional Engineer Seal: STATE OF VERMONT, MICHAEL S. CHRISTENSEN, NO. 133820, CIVIL, 10 DECEMBER 2020

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South End Retrofits

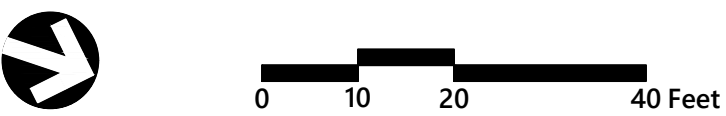S. Prospect St. and Prospect Pky
Burlington, VT

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Existing Conditions Plan

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Drawing Number

C-1.02

Sheet 5 of 24

Project Number
58126.01




South End Retrofits

S. Prospect St. and Prospect Pky
Burlington, VT

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Existing Conditions Plan

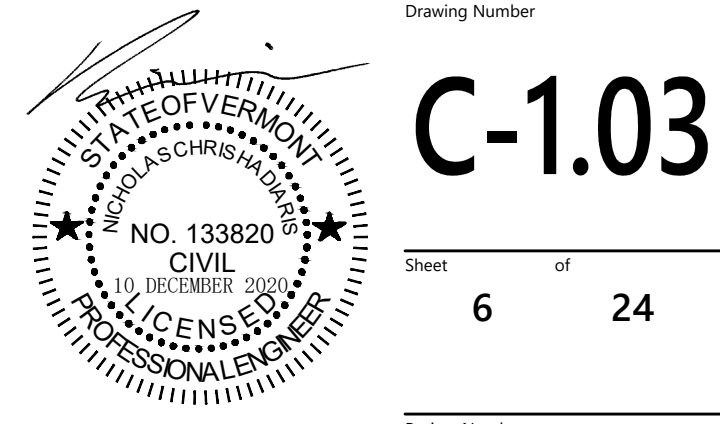


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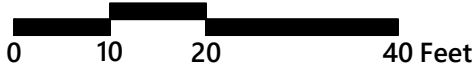


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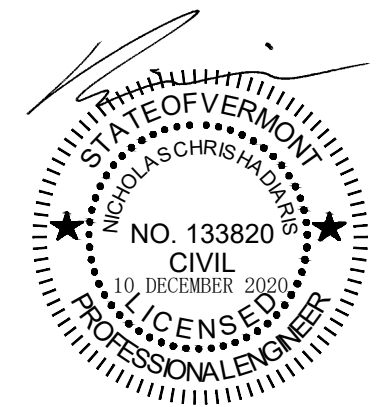
South End Retrofits
S. Prospect St. and Prospect Pky
Burlington, VT

No.	Revision	Date	Apprvd.
1	Street Name Revision	1/19/21	NCH

Designed by	RWN	Checked by	NCH
Issued for		Date	Dec. 10, 2020

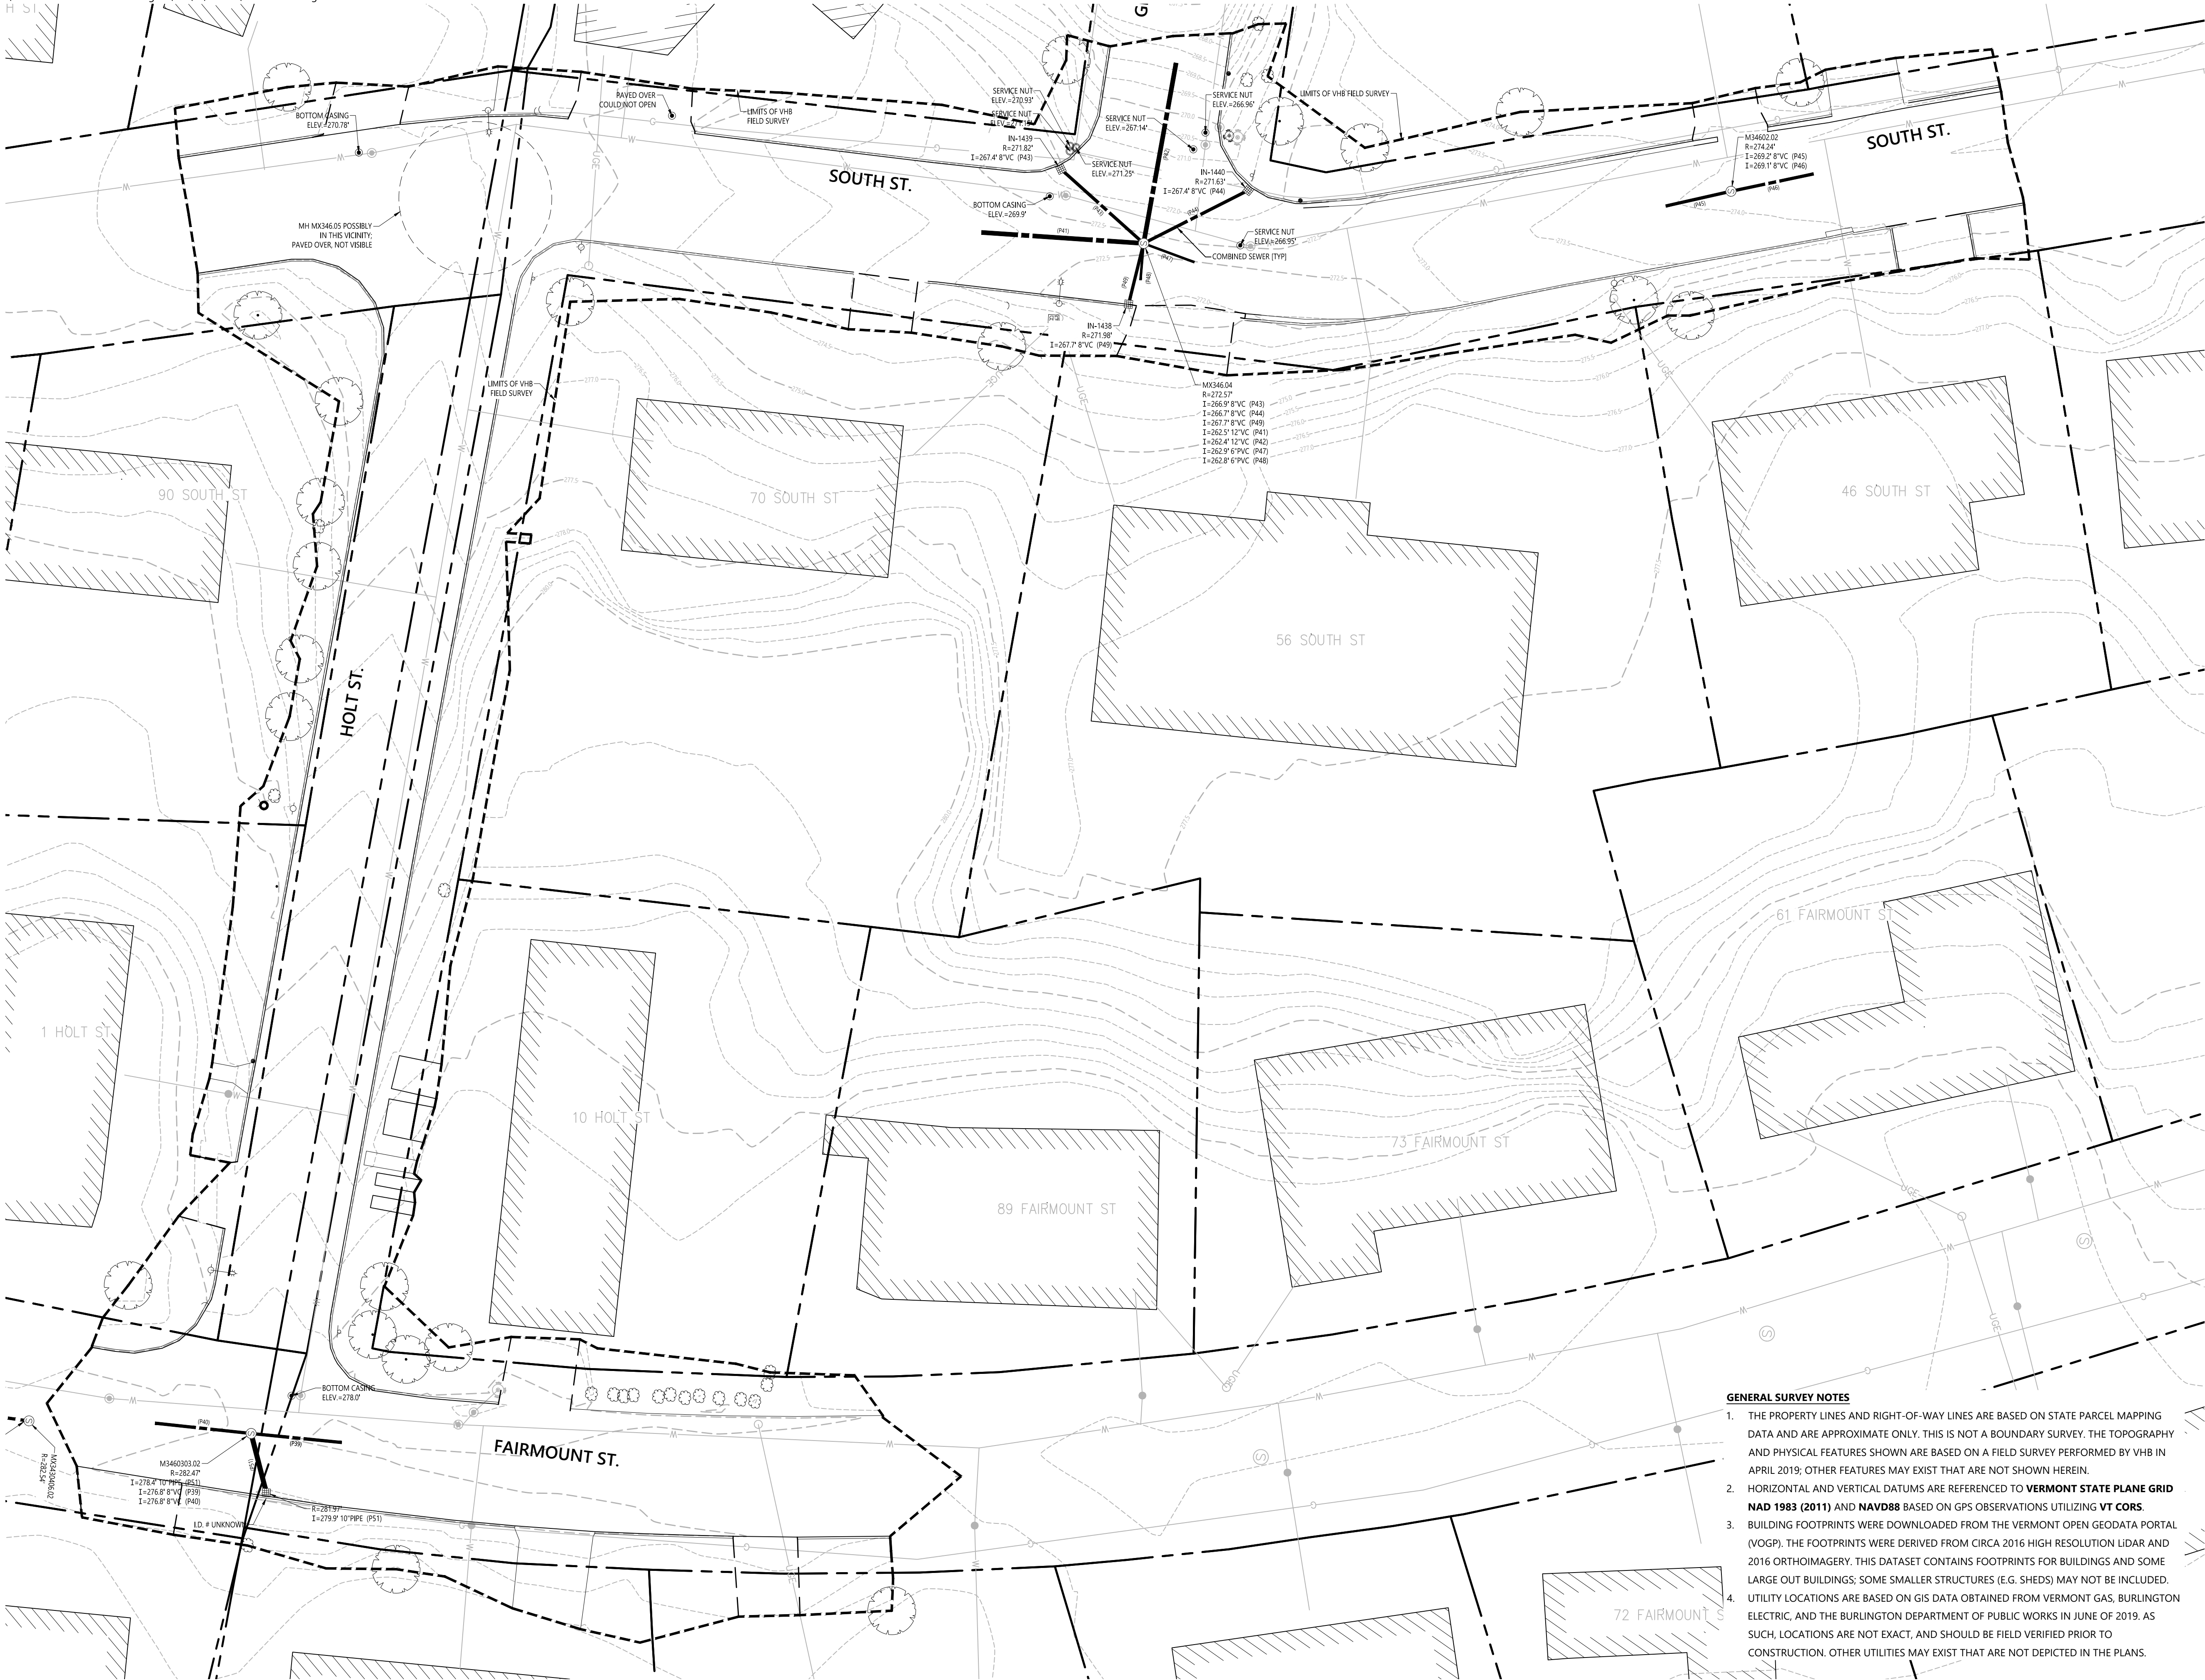Bid

Existing Conditions Plan





Drawing Number

C-1.04

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58126.01

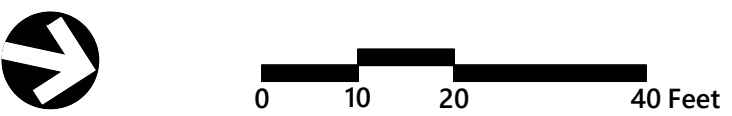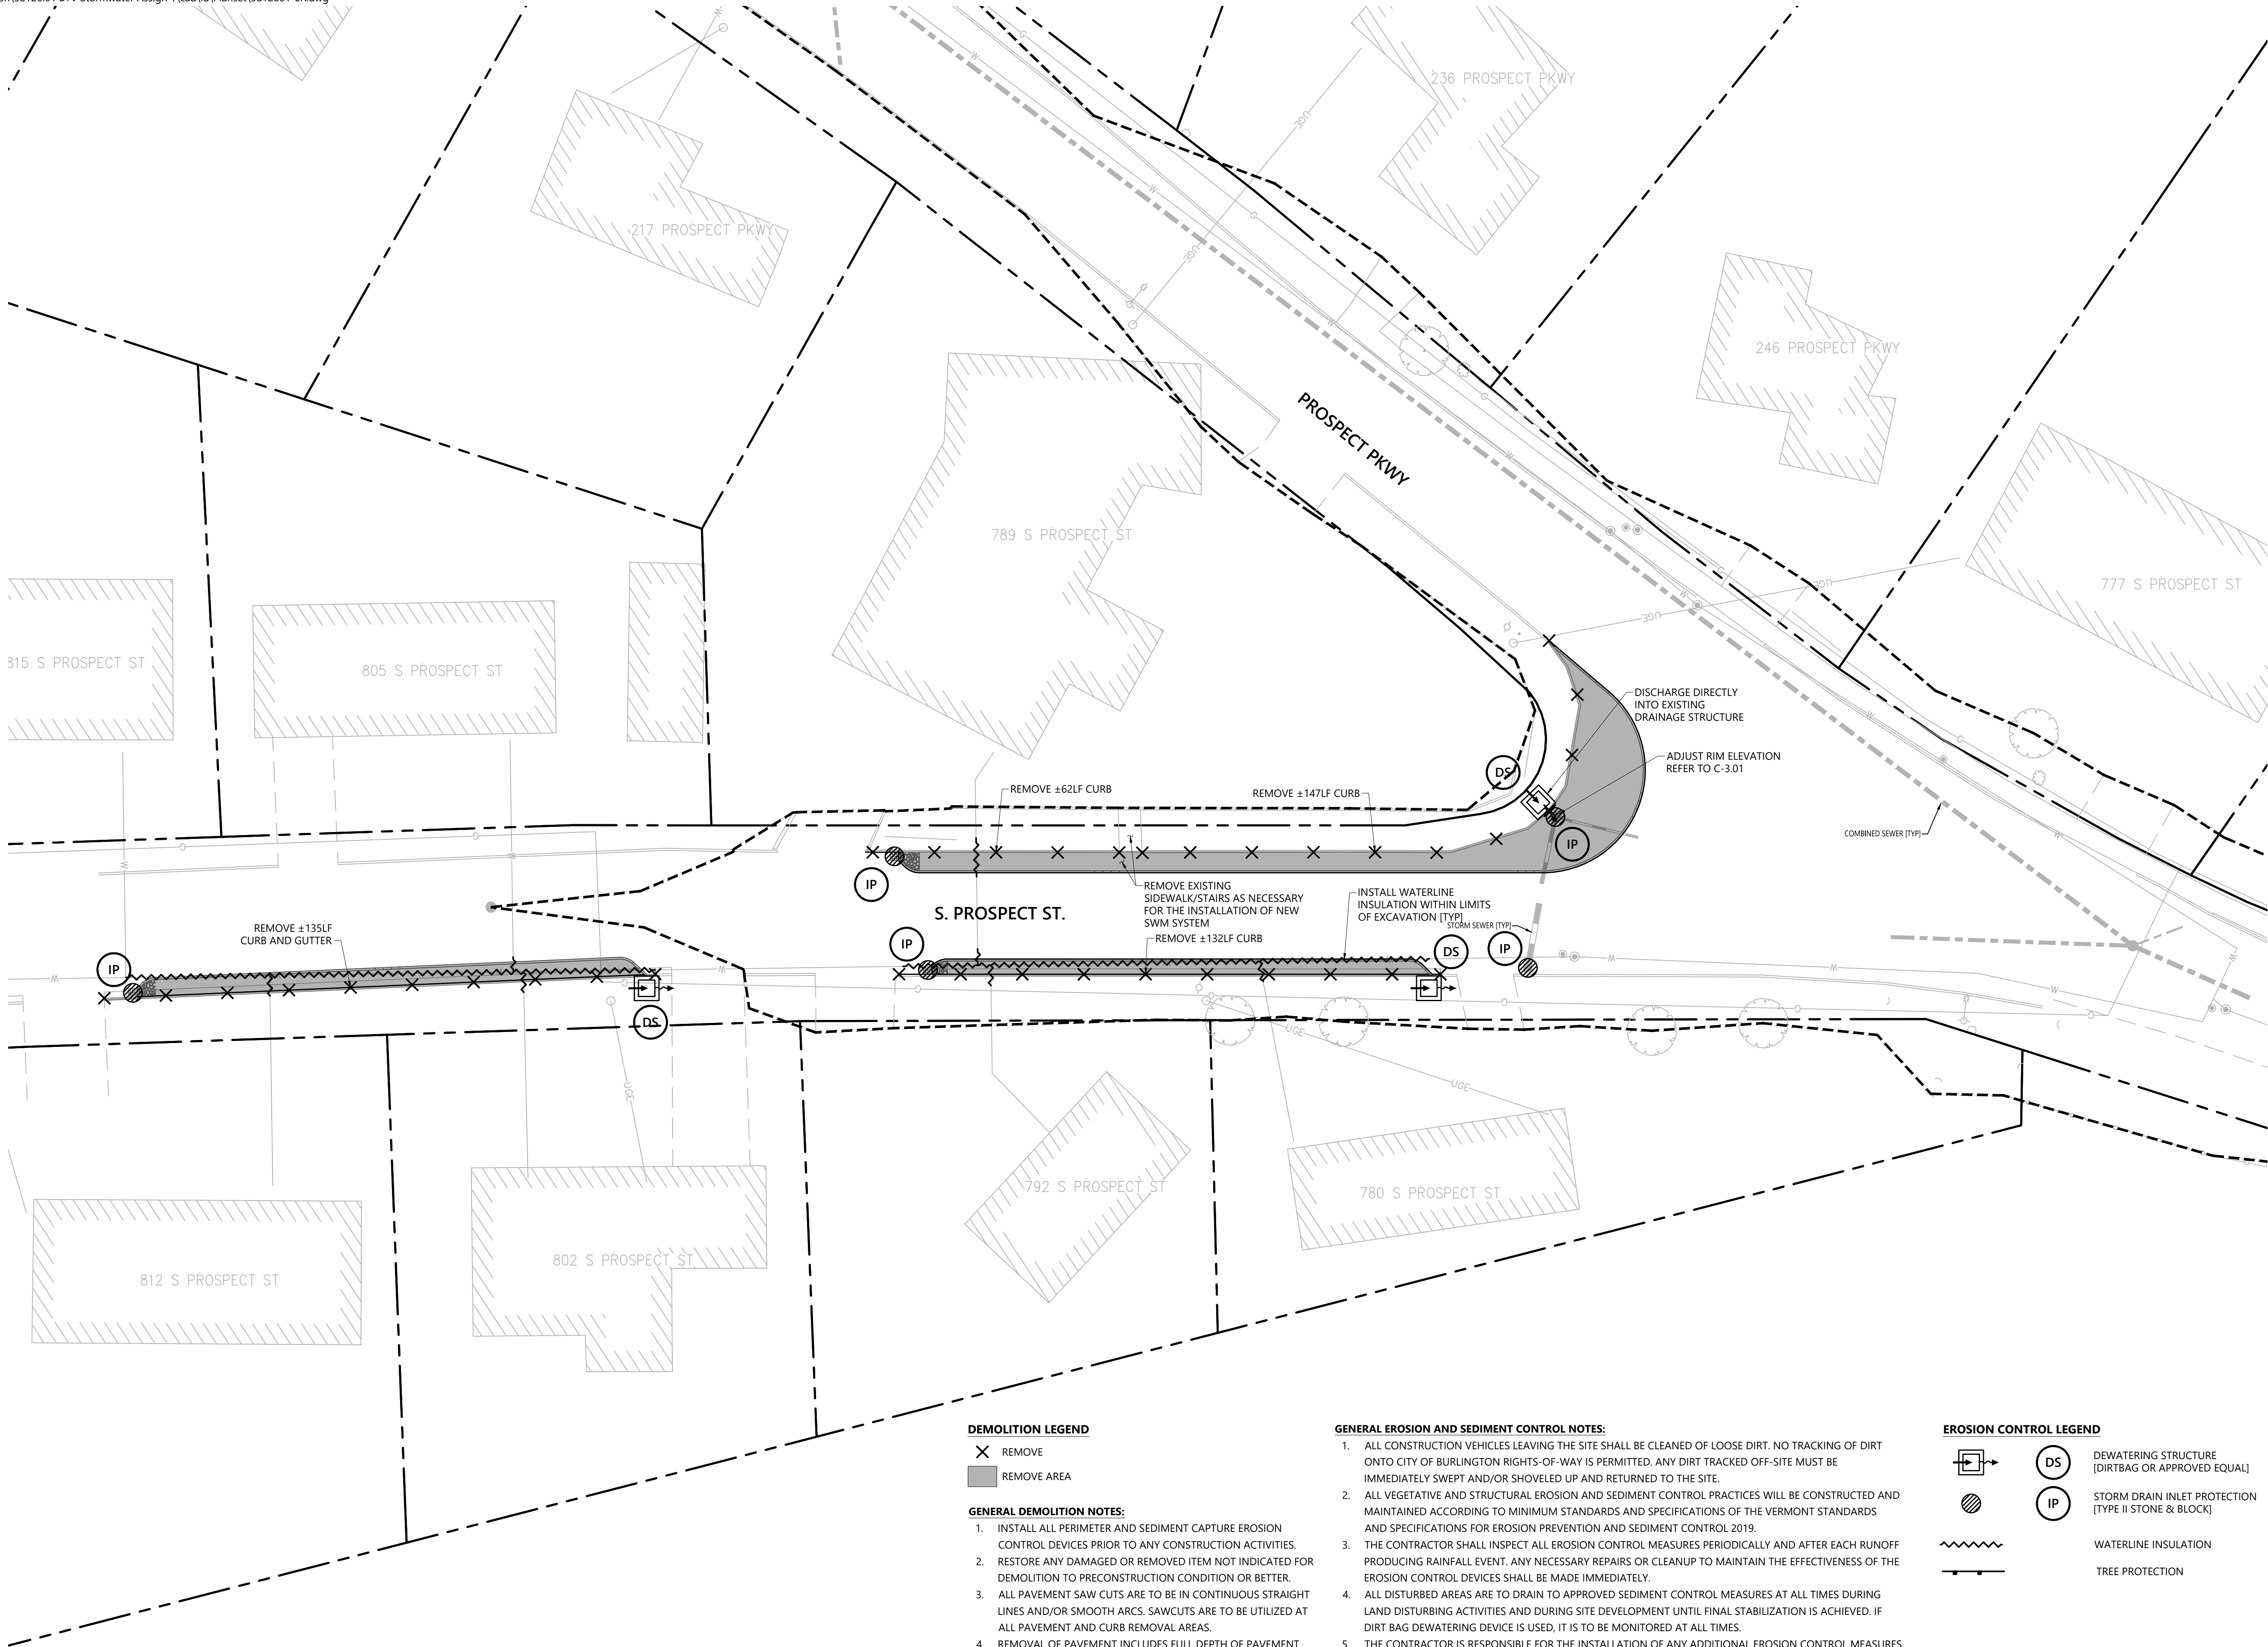

South End Retrofits


S. Prospect St. and Prospect Pky

Burlington, VT

No.	Revision	Date	Appvd.

Designed by	RWN	Checked by	NCH
Issued for	Bid	Date	Dec. 10, 2020

Demolition and Erosion Control Plan

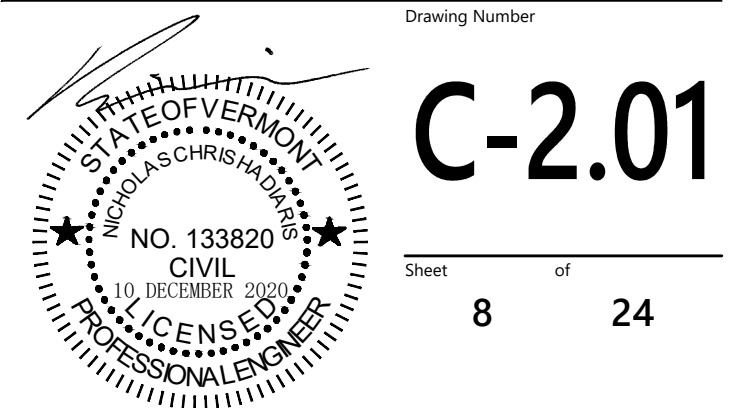

C-2.01

Sheet 8 of 24

Project Number
58126.01

DEMOLITION LEGEND

- X REMOVE
- REMOVE AREA

GENERAL DEMOLITION NOTES:


1. INSTALL ALL PERIMETER AND SEDIMENT CAPTURE EROSION CONTROL DEVICES PRIOR TO ANY CONSTRUCTION ACTIVITIES.
2. RESTORE ANY DAMAGED OR REMOVED ITEM NOT INDICATED FOR DEMOLITION TO PRECONSTRUCTION CONDITION OR BETTER.
3. ALL PAVEMENT SAW CUTS ARE TO BE IN CONTINUOUS STRAIGHT LINES AND/OR SMOOTH ARCS. SAWCUTS ARE TO BE UTILIZED AT ALL PAVEMENT AND CURB REMOVAL AREAS.
4. REMOVAL OF PAVEMENT INCLUDES FULL DEPTH OF PAVEMENT AND SUBBASE.

GENERAL EROSION AND SEDIMENT CONTROL NOTES:

1. ALL CONSTRUCTION VEHICLES LEAVING THE SITE SHALL BE CLEANED OF LOOSE DIRT. NO TRACKING OF DIRT ONTO CITY OF BURLINGTON RIGHTS-OF-WAY IS PERMITTED. ANY DIRT TRACKED OFF-SITE MUST BE IMMEDIATELY SWEEPED AND/OR SHOVELED UP AND RETURNED TO THE SITE.
2. ALL VEGETATIVE AND STRUCTURAL EROSION AND SEDIMENT CONTROL PRACTICES WILL BE CONSTRUCTED AND MAINTAINED ACCORDING TO MINIMUM STANDARDS AND SPECIFICATIONS OF THE VERMONT STANDARDS AND SPECIFICATIONS FOR EROSION PREVENTION AND SEDIMENT CONTROL 2019.
3. THE CONTRACTOR SHALL INSPECT ALL EROSION CONTROL MEASURES PERIODICALLY AND AFTER EACH RUNOFF PRODUCING RAINFALL EVENT. ANY NECESSARY REPAIRS OR CLEANUP TO MAINTAIN THE EFFECTIVENESS OF THE EROSION CONTROL DEVICES SHALL BE MADE IMMEDIATELY.
4. ALL DISTURBED AREAS ARE TO DRAIN TO APPROVED SEDIMENT CONTROL MEASURES AT ALL TIMES DURING LAND DISTURBING ACTIVITIES AND DURING SITE DEVELOPMENT UNTIL FINAL STABILIZATION IS ACHIEVED. IF DIRT BAG DEWATERING DEVICE IS USED, IT IS TO BE MONITORED AT ALL TIMES.
5. THE CONTRACTOR IS RESPONSIBLE FOR THE INSTALLATION OF ANY ADDITIONAL EROSION CONTROL MEASURES NECESSARY TO PREVENT EROSION AND SEDIMENTATION AS DETERMINED BY THE ENVIRONMENTAL ENGINEERING DEPARTMENT.
6. REFER TO THE **WATERLINE INSULATION DETAIL** ON DRAWING C-4.02 FOR RETROFIT OF INSULATION FOR WATERMAINS AND DOMESTIC SERVICE LINES.

EROSION CONTROL LEGEND

- DS DEWATERING STRUCTURE [DIRTBAG OR APPROVED EQUAL]
- IP STORM DRAIN INLET PROTECTION [TYPE II STONE & BLOCK]
- WATERLINE INSULATION
- TREE PROTECTION

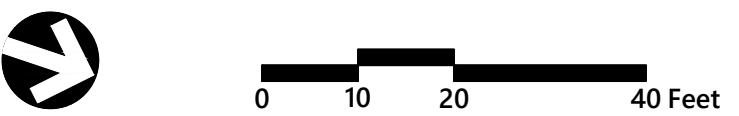

South End Retrofits

S. Prospect St. and Prospect Pky
Burlington, VT

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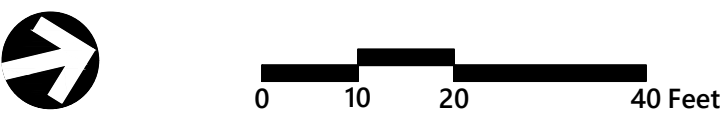
Demolition and Erosion Control Plan

Drawing Number

C-2.02

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Project Number
58126.01






South End Retrofits

S. Prospect St. and Prospect Pky
Burlington, VT

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Demolition and Erosion Control Plan



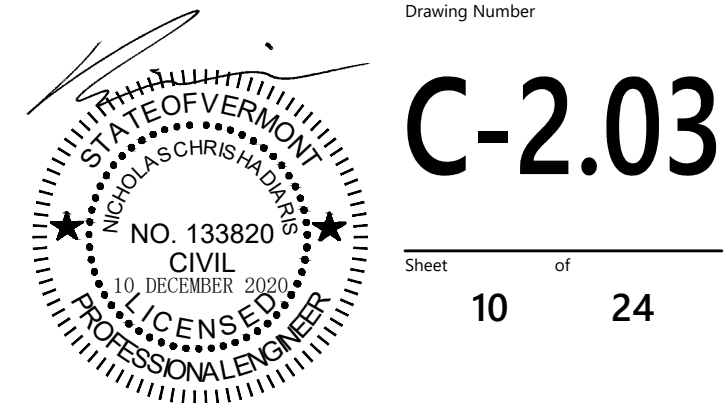

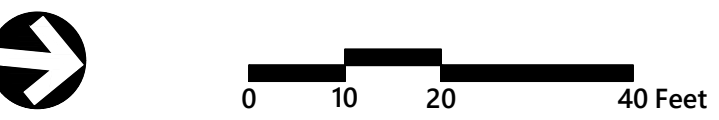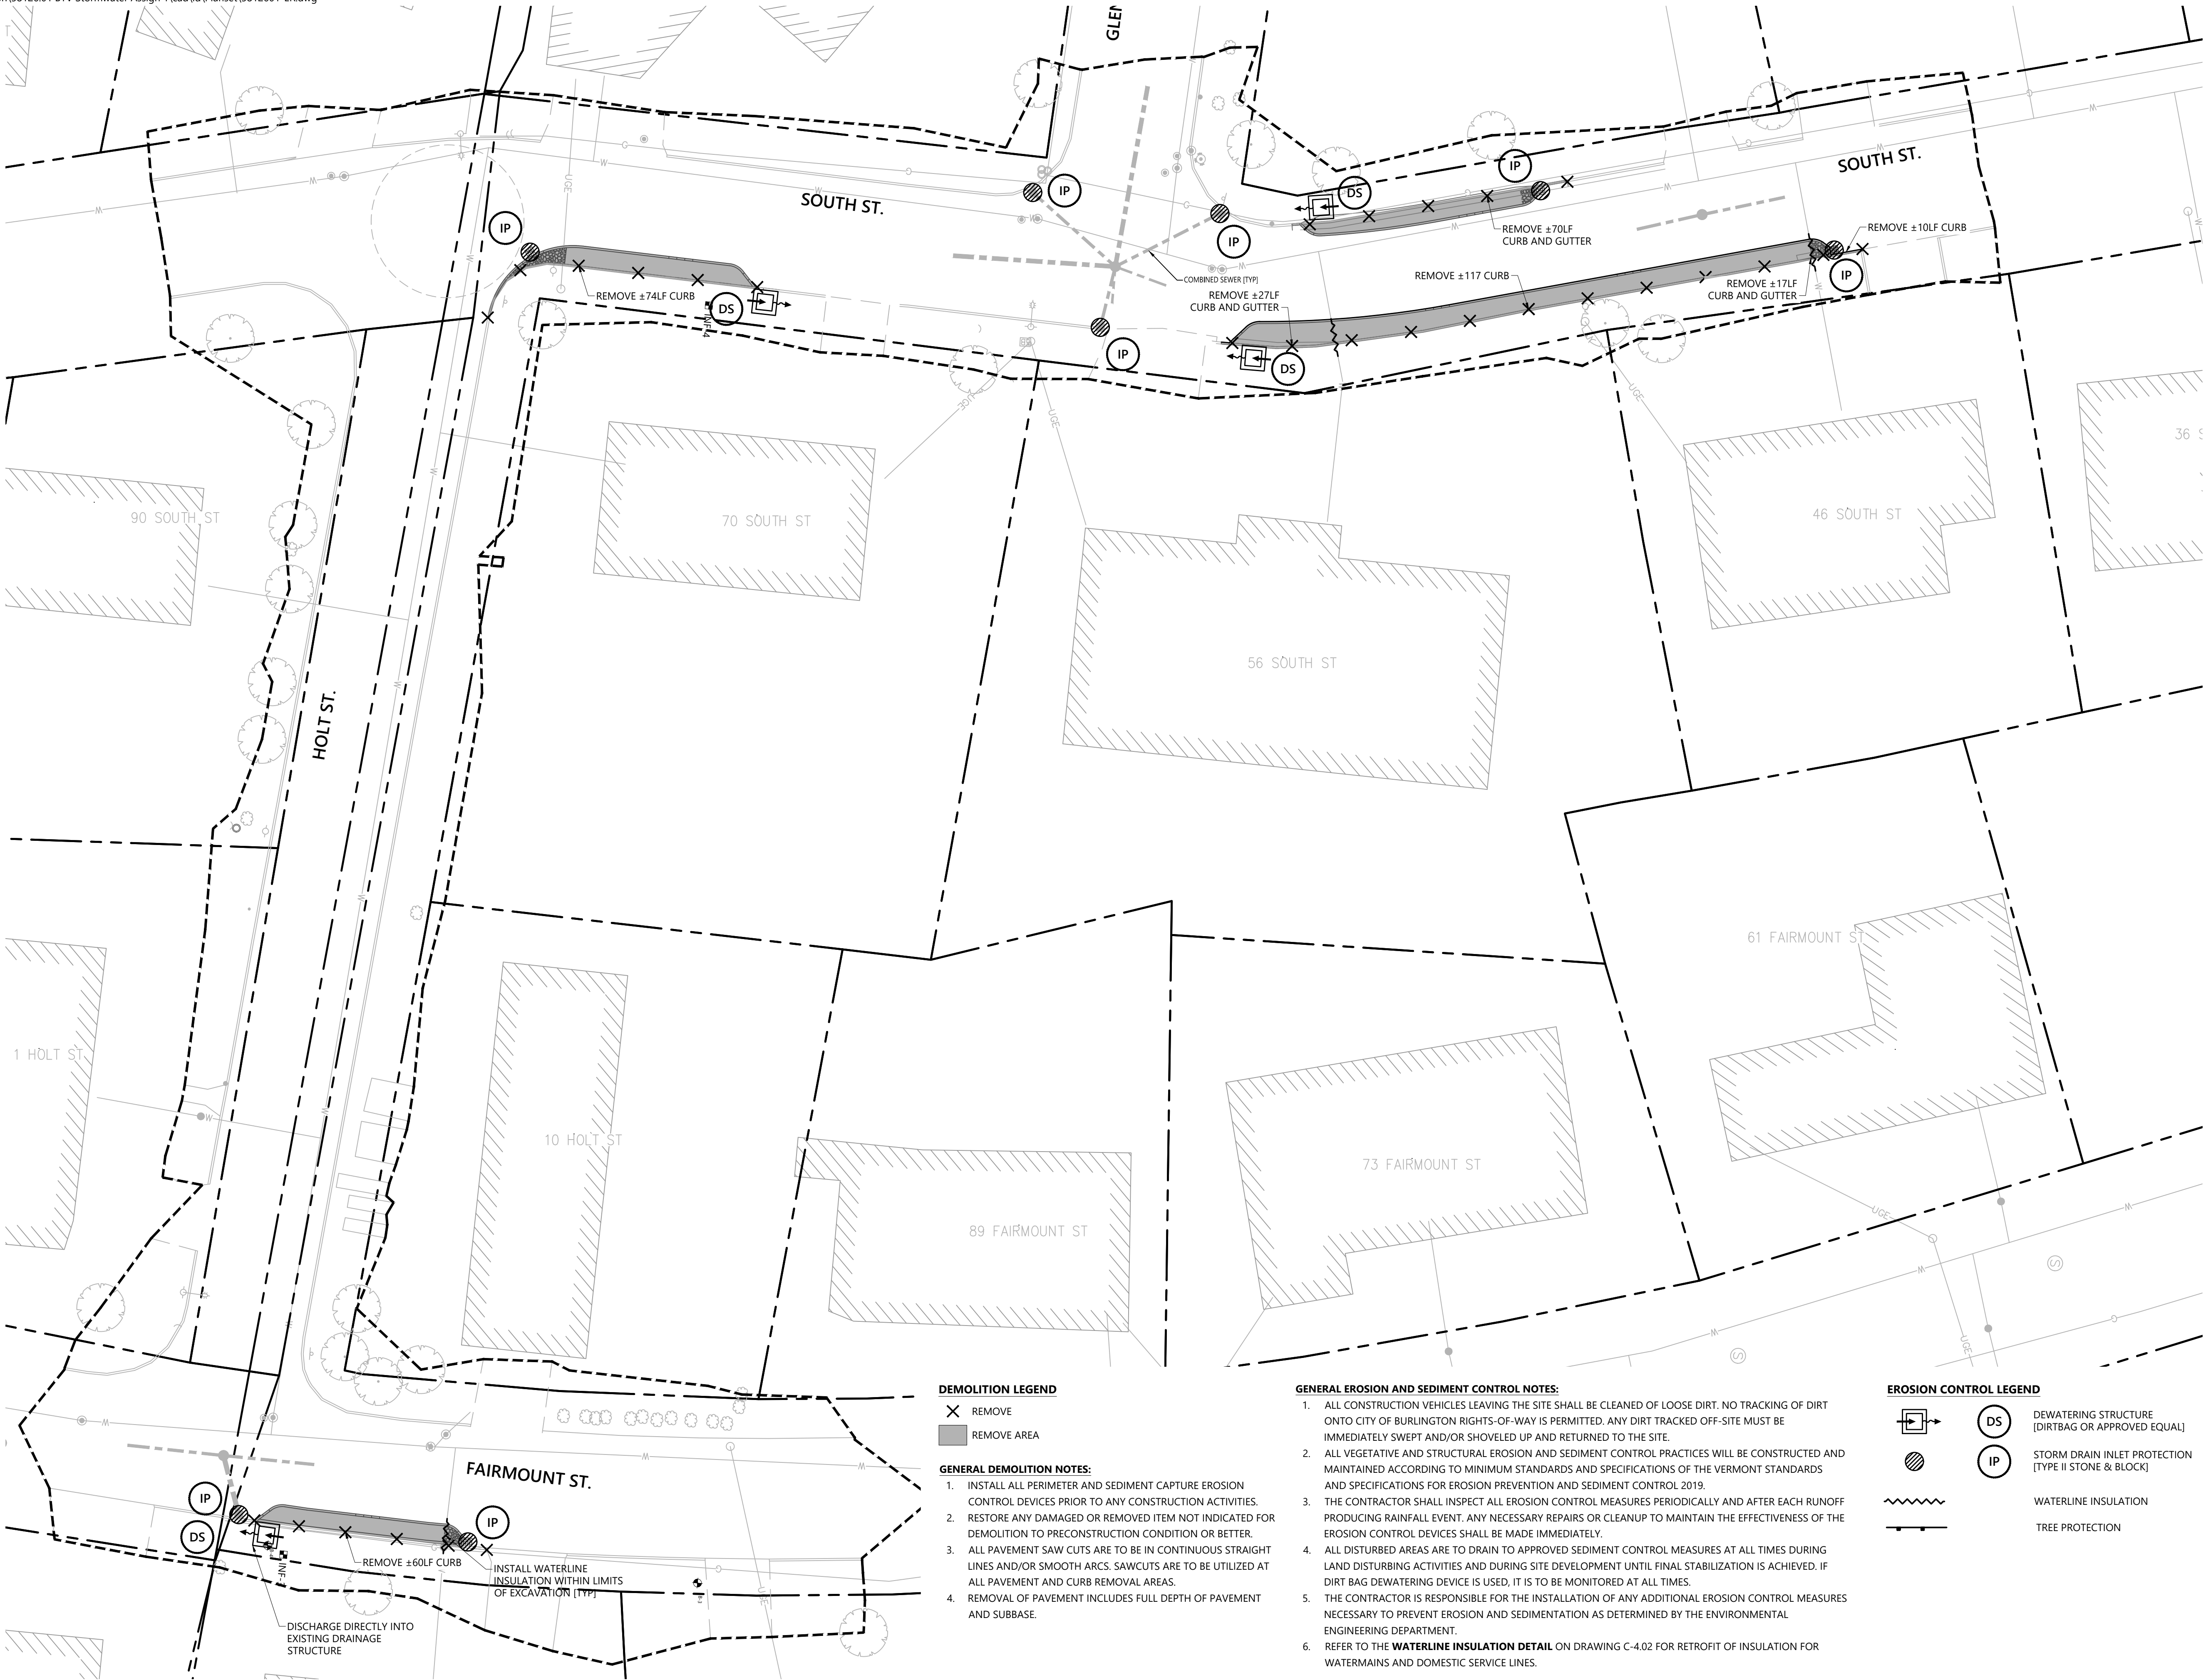South End Retrofits
S. Prospect St. and Prospect Pky
Burlington, VT

No.	Revision	Date	Apprd.
1	Street Name Revision	1/19/21	NCH

Designed by	RWN	Checked by	NCH
Issued for	Bid	Date	Dec. 10, 2020

Demolition and Erosion
Control Plan

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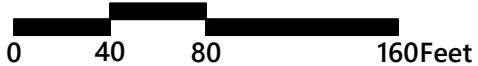
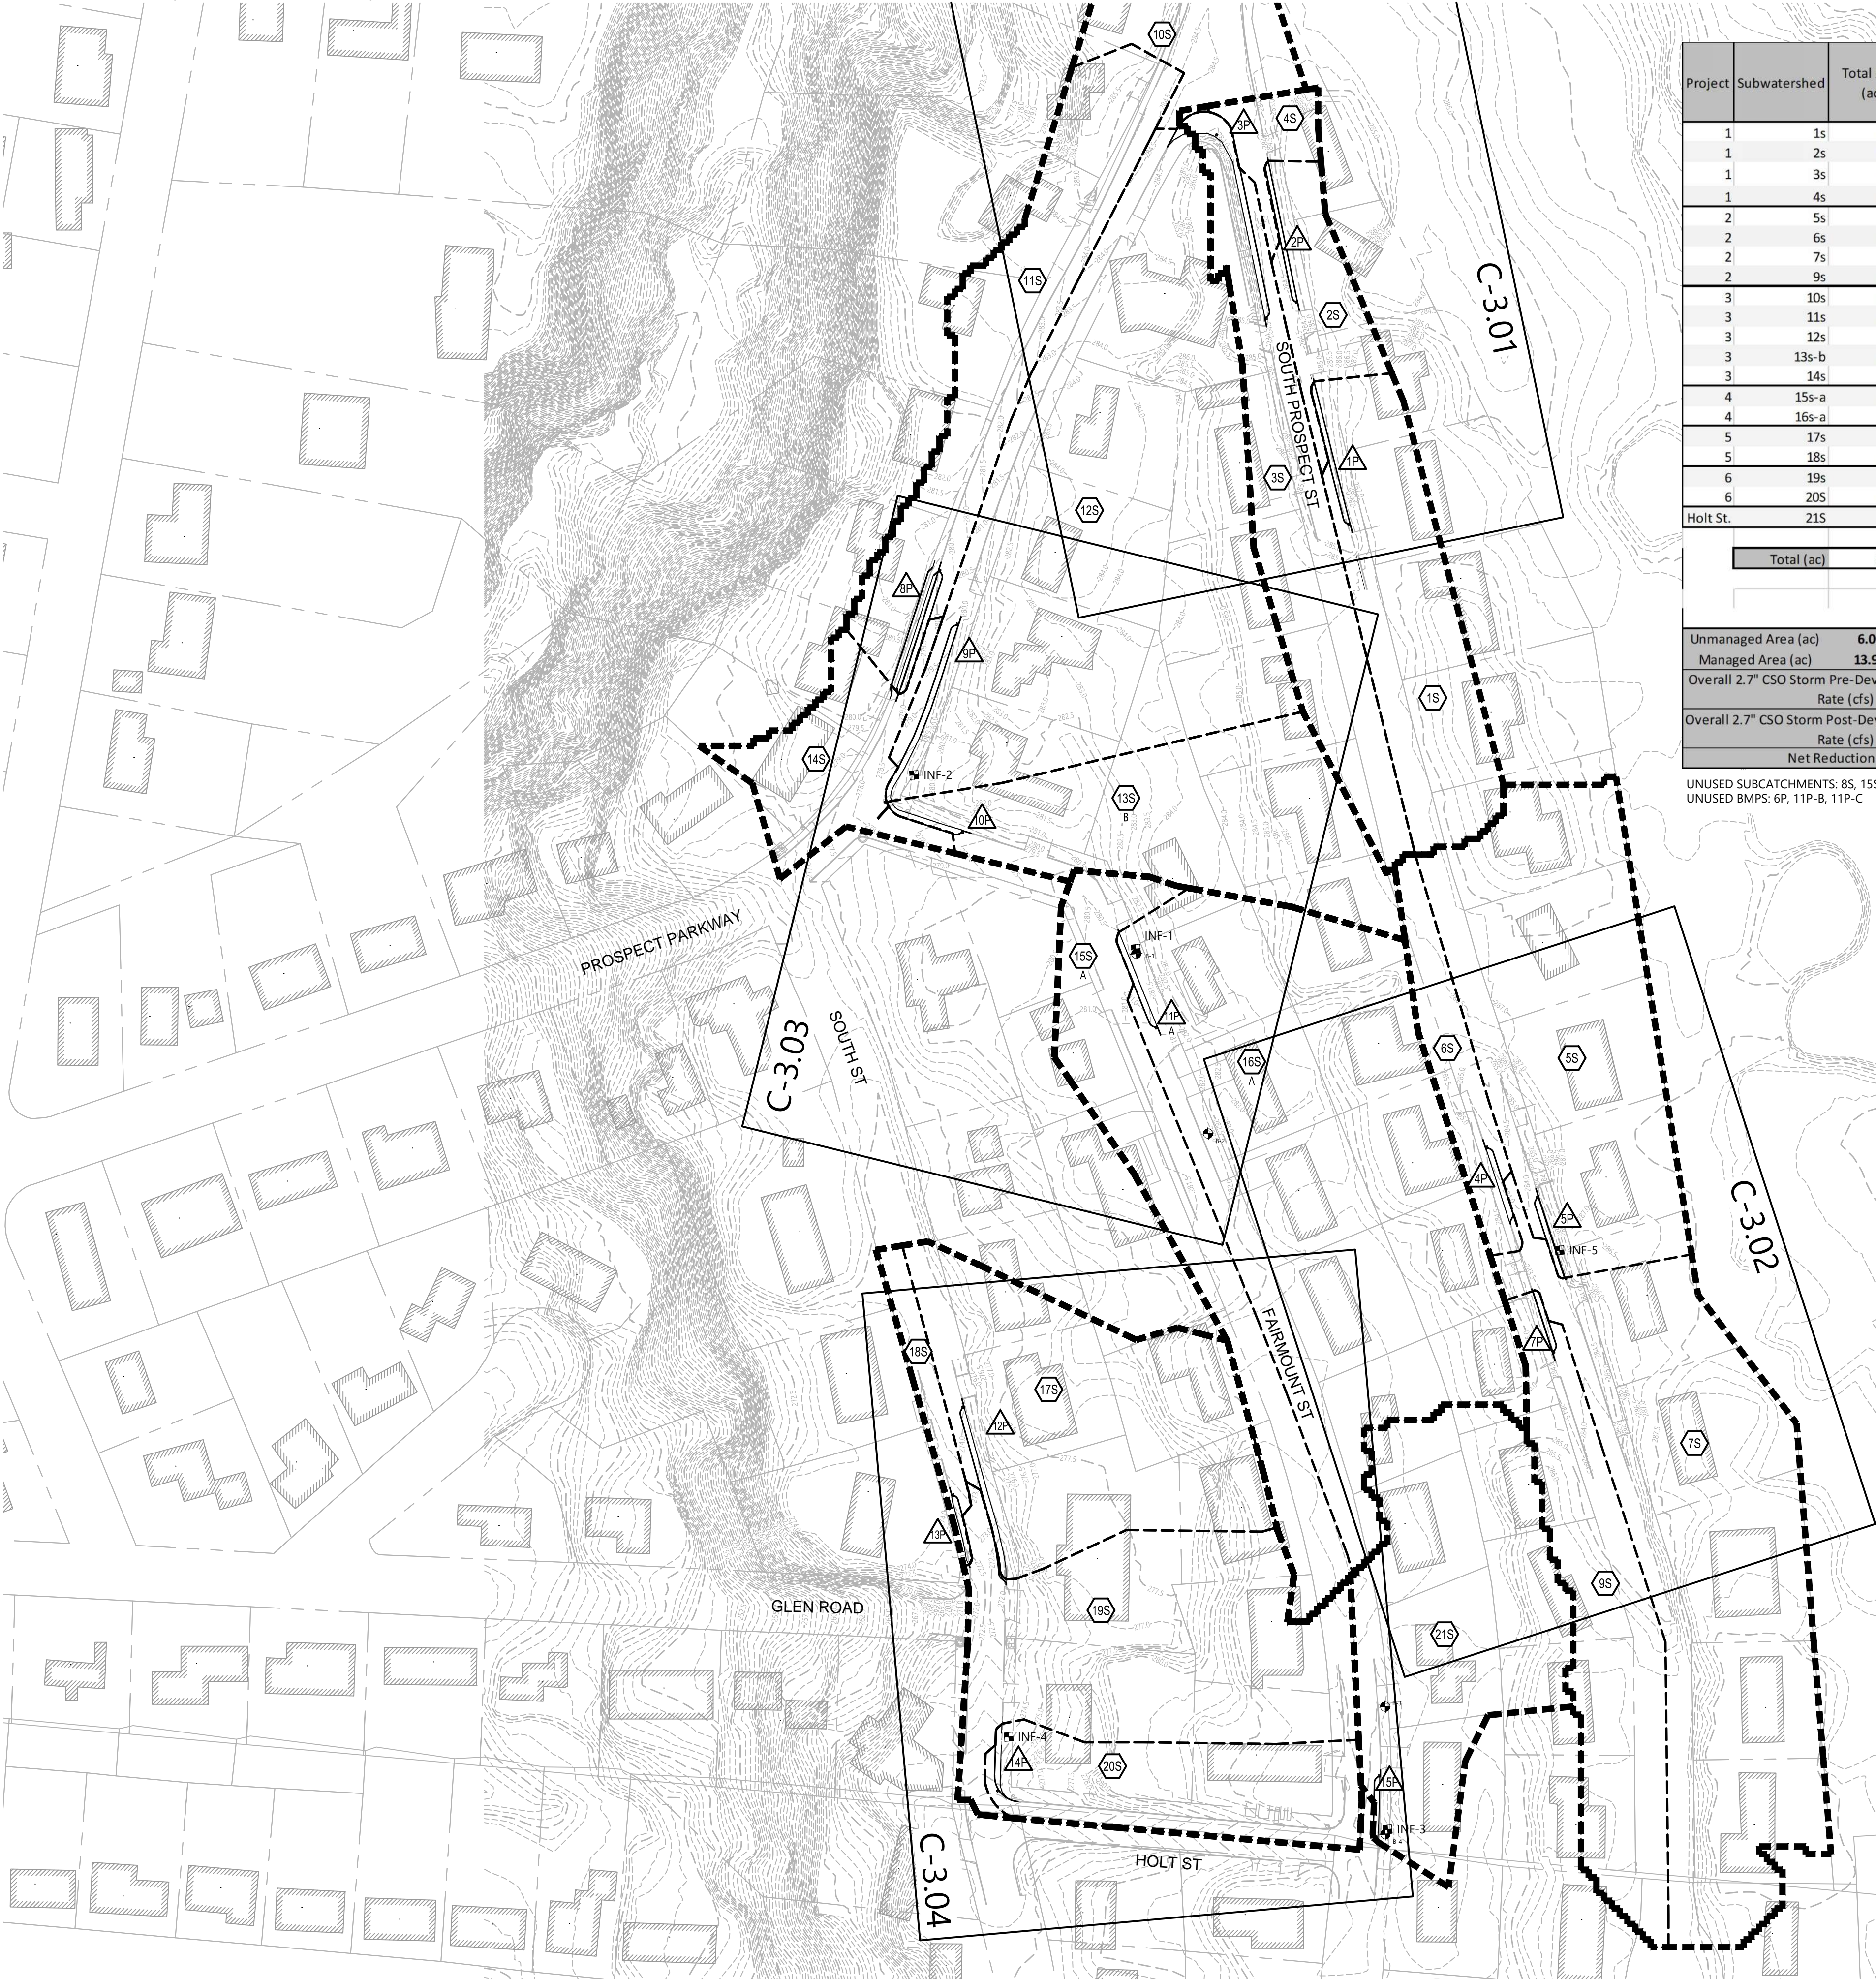


40 IDX Dr
Building 100 Suite 200
South Burlington, VT 05403
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STORMWATER SUMMARY TABLE									
Project	Subwatershed	Total Area (ac)	Impervious Area (ac)	Pervious Area (ac)	Treatment Practice	Approx. Area of Practice (sqft)	Approx. Length of Practice (ft)	Primary Outlet Outflow (downstream curb notch) (af) (2.7" CSO Storm)	Discarded (Infiltration) (af) (2.7" CSO Storm)
1	1s	0.756	0.346	0.410	1P	495	120	*	0.048
1	2s	0.278	0.105	0.172	2P	531	137	0.053	0.039
1	3s	0.772	0.283	0.489	3P	1395	248	0.007	0.091
1	4s	0.119	0.070	0.048					
2	5s	1.398	0.374	1.024	5P	315	87	0.093	0.067
2	6s	0.266	0.103	0.163	4P	250	64	0.007	0.028
2	7s	1.824	0.335	1.489					
2	9s	0.792	0.295	0.497	7P	226	70	0.055	0.046
3	10s	0.684	0.316	0.368					
3	11s	0.877	0.290	0.588	8P	504	115	0	0.060
3	12s	2.467	0.627	1.840	9P	712	160	0.010	0.119
3	13s-b	0.952	0.151	0.801	10P	294	135	0	0.031
3	14s	1.387	0.479	0.908					
4	15s-a	0.760	0.336	0.424					
4	16s-a	2.339	0.744	1.595	11P-A	367	101	0.045	0.108
5	17s	1.191	0.375	0.816	12P	651	164	0.010	0.067
5	18s	0.127	0.072	0.055	13P	225	60	0	0.015
6	19s	1.245	0.451	0.794					
6	20s	0.559	0.118	0.441	14P	239	64	0	0.024
Holt St.	21S	1.225	0.447	0.778	15P	230	51	0.030	0.062
Total (ac)		20.018	6.317	13.700		6434	1576	0.310	0.805

Unmanaged Area (ac)	6.019	*System primary outlet flows into another downstream system.	Percent (%) of	
Managed Area (ac)	13.999	Removed to prevent "double counting" in Primary Outlet Total.	"Managed Area" CSO Storm Runoff Infiltrated by Volume	72.2
Overall 2.7" CSO Storm Pre-Development Peak Flow Rate (cfs)	36.19			
Overall 2.7" CSO Storm Post-Development Peak Flow Rate (cfs)	26.22			
Net Reduction (cfs)	10.0			

UNUSED SUBCATCHMENTS: 8S, 15S-B, 16S-B
UNUSED BMPs: 6P, 11P-B, 11P-C



South End Retrofits
S. Prospect St. and Prospect Pky
Burlington, VT

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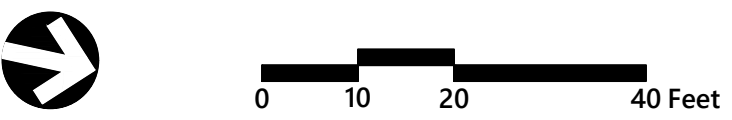
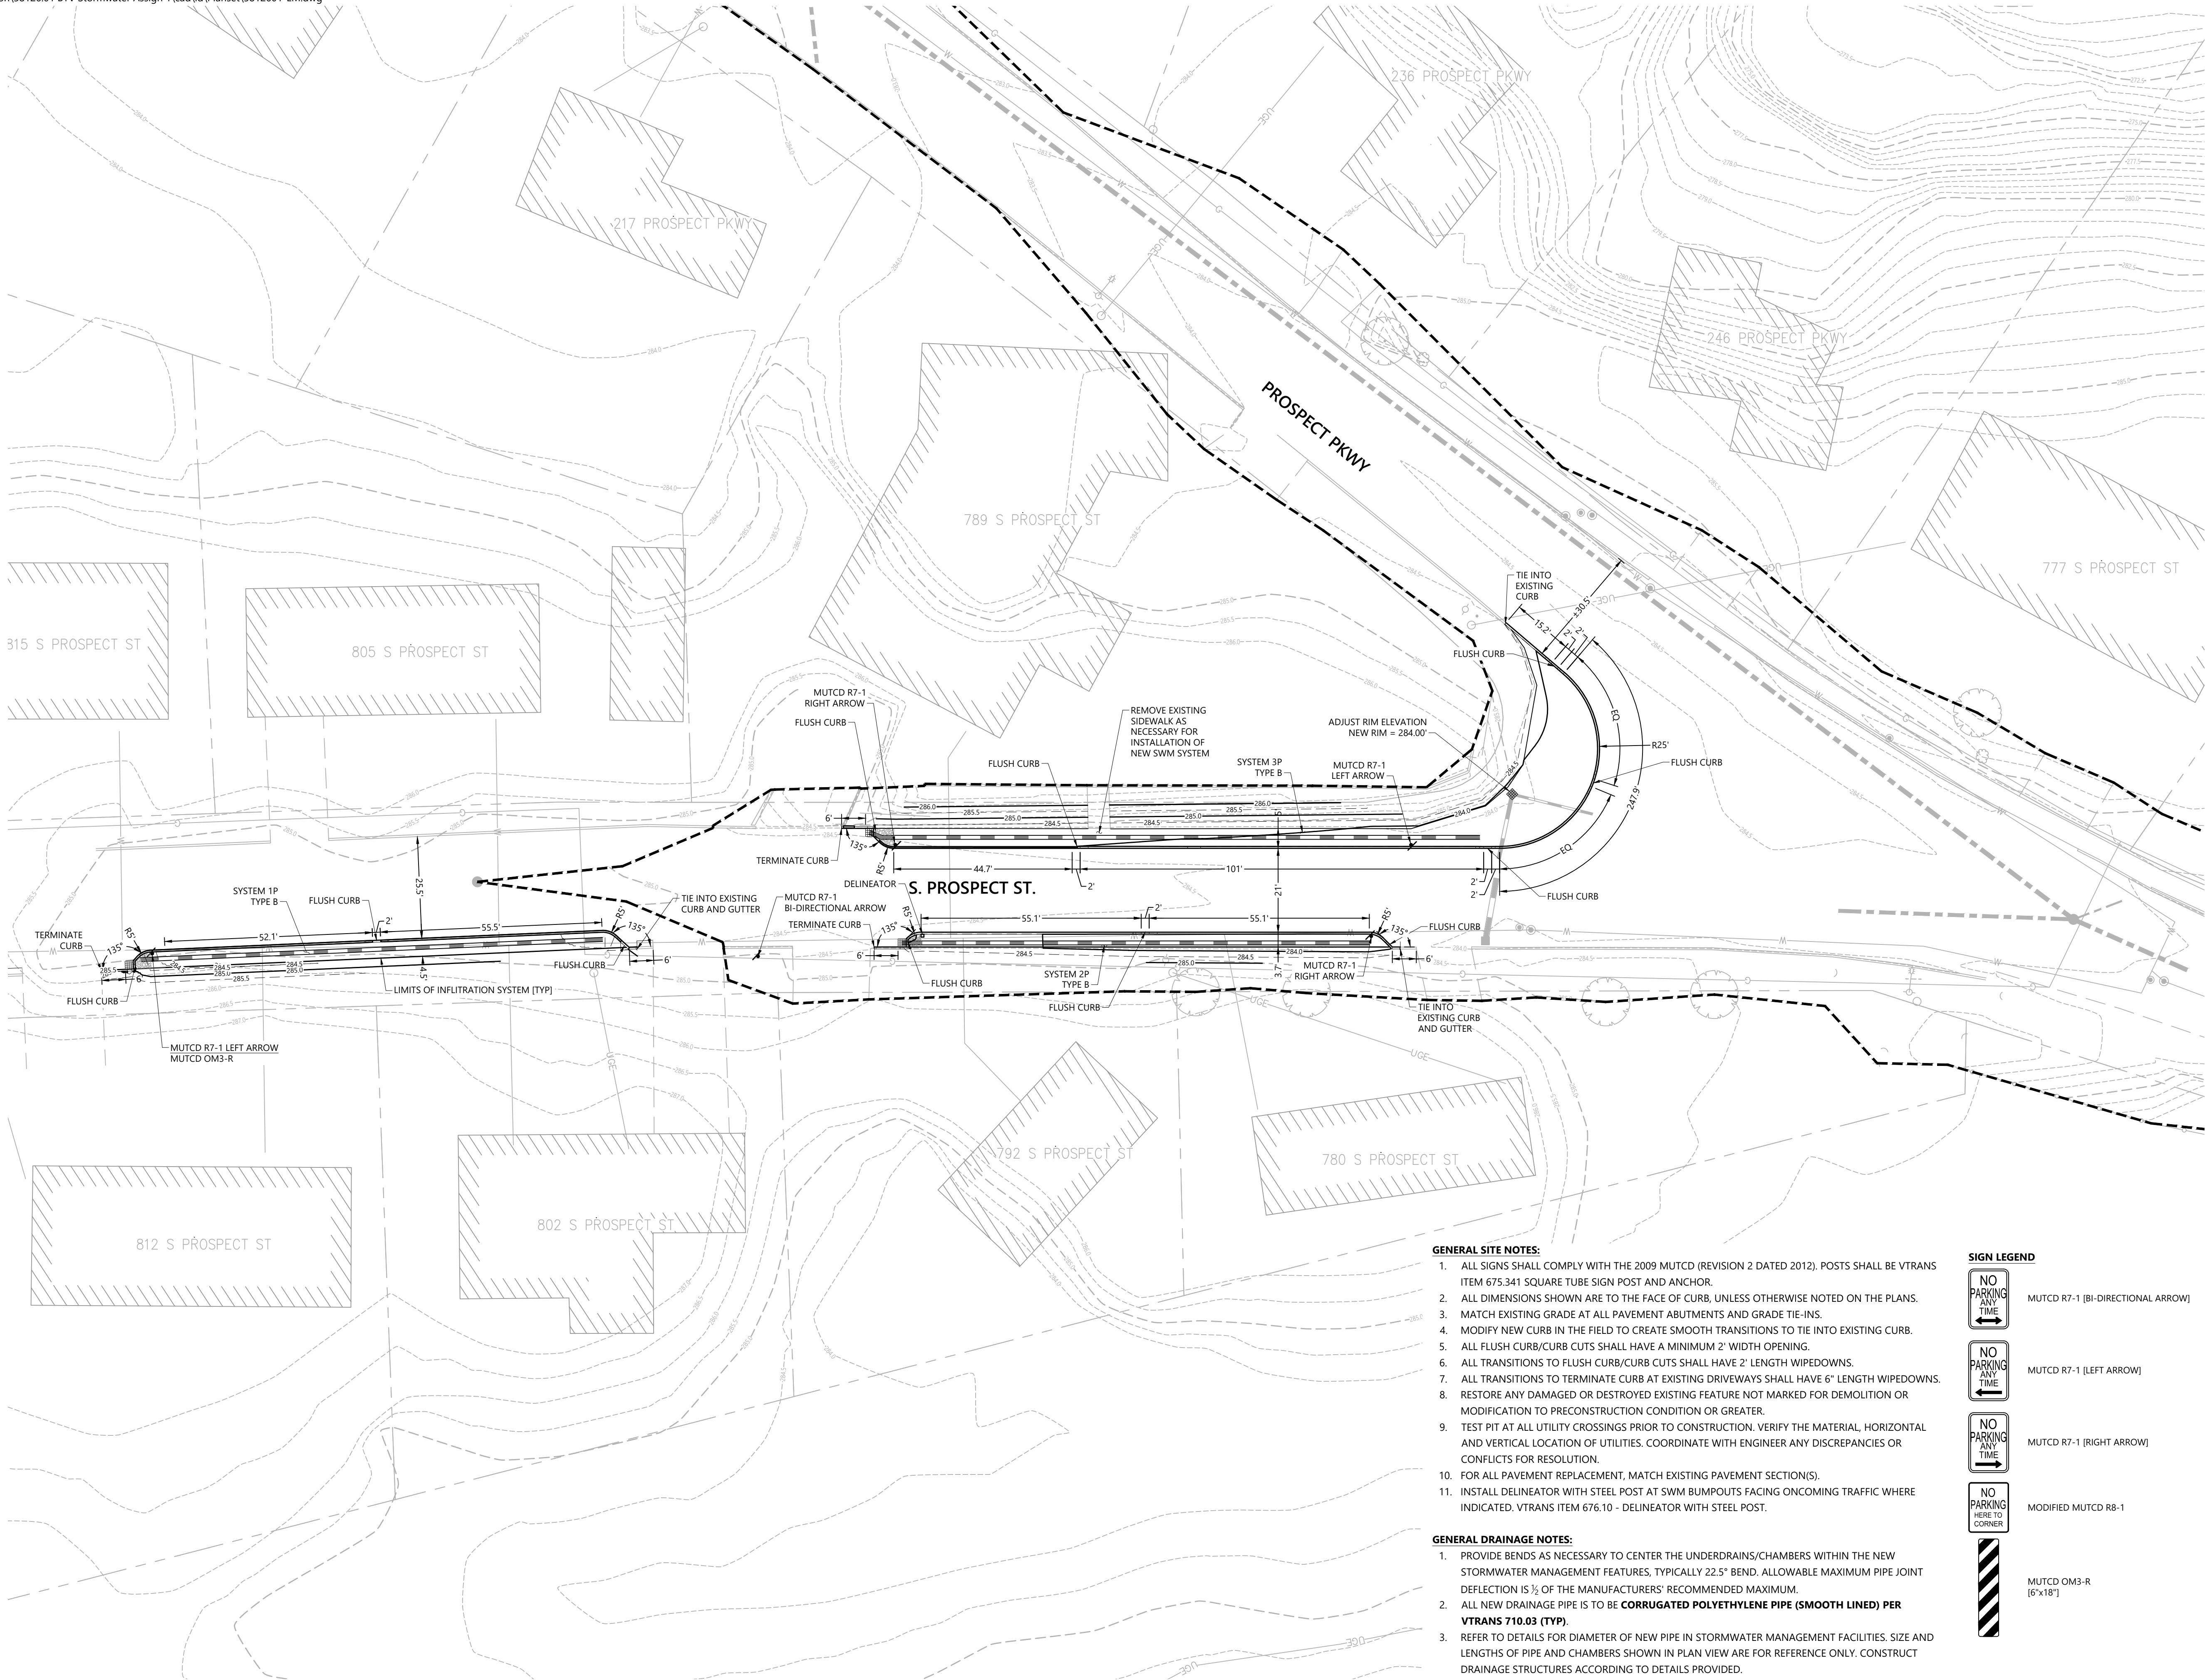
LINETYPE AND SYMBOL LEGEND

- STORMWATER MANAGEMENT IDENTIFICATION
- SUBCATCHMENT DRAINAGE AREA IDENTIFICATION
- MAJOR DRAINAGE AREA DELINEATION
- MINOR DRAINAGE AREA DELINEATION

Overall Layout and
Materials Plan

C-3.00

Sheet 12 of 24



South End Retrofits S. Prospect St. and Prospect Pky Burlington, VT

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Layout and Materials Plan

Drawing Title

Drawing Number

C-3.01

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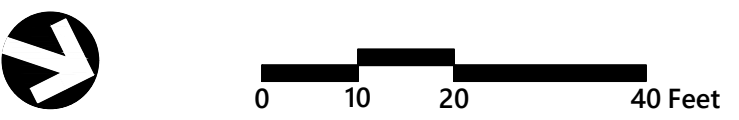
Project Number 58126.01

Professional Engineer Seal: STATE OF VERMONT, No. 133820, CIVIL, 10 DECEMBER 2020, CHRISTOPHER J. CHASE, PROFESSIONAL ENGINEER

- GENERAL SITE NOTES:**
1. ALL SIGNS SHALL COMPLY WITH THE 2009 MUTCD (REVISION 2 DATED 2012). POSTS SHALL BE VTRANS ITEM 675.341 SQUARE TUBE SIGN POST AND ANCHOR.
 2. ALL DIMENSIONS SHOWN ARE TO THE FACE OF CURB, UNLESS OTHERWISE NOTED ON THE PLANS.
 3. MATCH EXISTING GRADE AT ALL PAVEMENT ABUTMENTS AND GRADE TIE-INS.
 4. MODIFY NEW CURB IN THE FIELD TO CREATE SMOOTH TRANSITIONS TO TIE INTO EXISTING CURB.
 5. ALL FLUSH CURB/CURB CUTS SHALL HAVE A MINIMUM 2' WIDTH OPENING.
 6. ALL TRANSITIONS TO FLUSH CURB/CURB CUTS SHALL HAVE 2' LENGTH WIPEDOWNS.
 7. ALL TRANSITIONS TO TERMINATE CURB AT EXISTING DRIVEWAYS SHALL HAVE 6" LENGTH WIPEDOWNS.
 8. RESTORE ANY DAMAGED OR DESTROYED EXISTING FEATURE NOT MARKED FOR DEMOLITION OR MODIFICATION TO PRECONSTRUCTION CONDITION OR GREATER.
 9. TEST PIT AT ALL UTILITY CROSSINGS PRIOR TO CONSTRUCTION. VERIFY THE MATERIAL, HORIZONTAL AND VERTICAL LOCATION OF UTILITIES. COORDINATE WITH ENGINEER ANY DISCREPANCIES OR CONFLICTS FOR RESOLUTION.
 10. FOR ALL PAVEMENT REPLACEMENT, MATCH EXISTING PAVEMENT SECTION(S).
 11. INSTALL DELINEATOR WITH STEEL POST AT SWM BUMPOUTS FACING ONCOMING TRAFFIC WHERE INDICATED. VTRANS ITEM 676.10 - DELINEATOR WITH STEEL POST.
- GENERAL DRAINAGE NOTES:**
1. PROVIDE BENDS AS NECESSARY TO CENTER THE UNDERDRAINS/CHAMBERS WITHIN THE NEW STORMWATER MANAGEMENT FEATURES. TYPICALLY 22.5° BEND. ALLOWABLE MAXIMUM PIPE JOINT DEFLECTION IS 1/2 OF THE MANUFACTURERS' RECOMMENDED MAXIMUM.
 2. ALL NEW DRAINAGE PIPE IS TO BE **CORRUGATED POLYETHYLENE PIPE (SMOOTH LINED) PER VTRANS 710.03 (TYP)**.
 3. REFER TO DETAILS FOR DIAMETER OF NEW PIPE IN STORMWATER MANAGEMENT FACILITIES. SIZE AND LENGTHS OF PIPE AND CHAMBERS SHOWN IN PLAN VIEW ARE FOR REFERENCE ONLY. CONSTRUCT DRAINAGE STRUCTURES ACCORDING TO DETAILS PROVIDED.

SIGN LEGEND

	MUTCD R7-1 [BI-DIRECTIONAL ARROW]
	MUTCD R7-1 [LEFT ARROW]
	MUTCD R7-1 [RIGHT ARROW]
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	MUTCD OM3-R [6'x18"]




South End Retrofits

S. Prospect St. and Prospect Pky
Burlington, VT



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Layout and Materials Plan

Project Number
58126.01

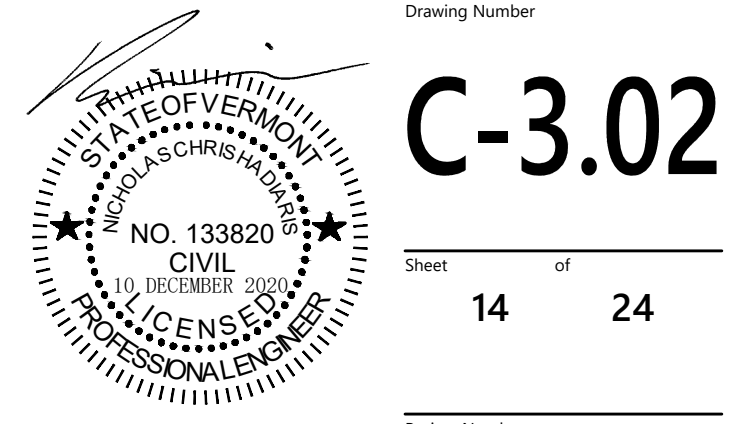

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802.497.6100

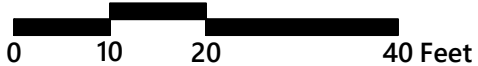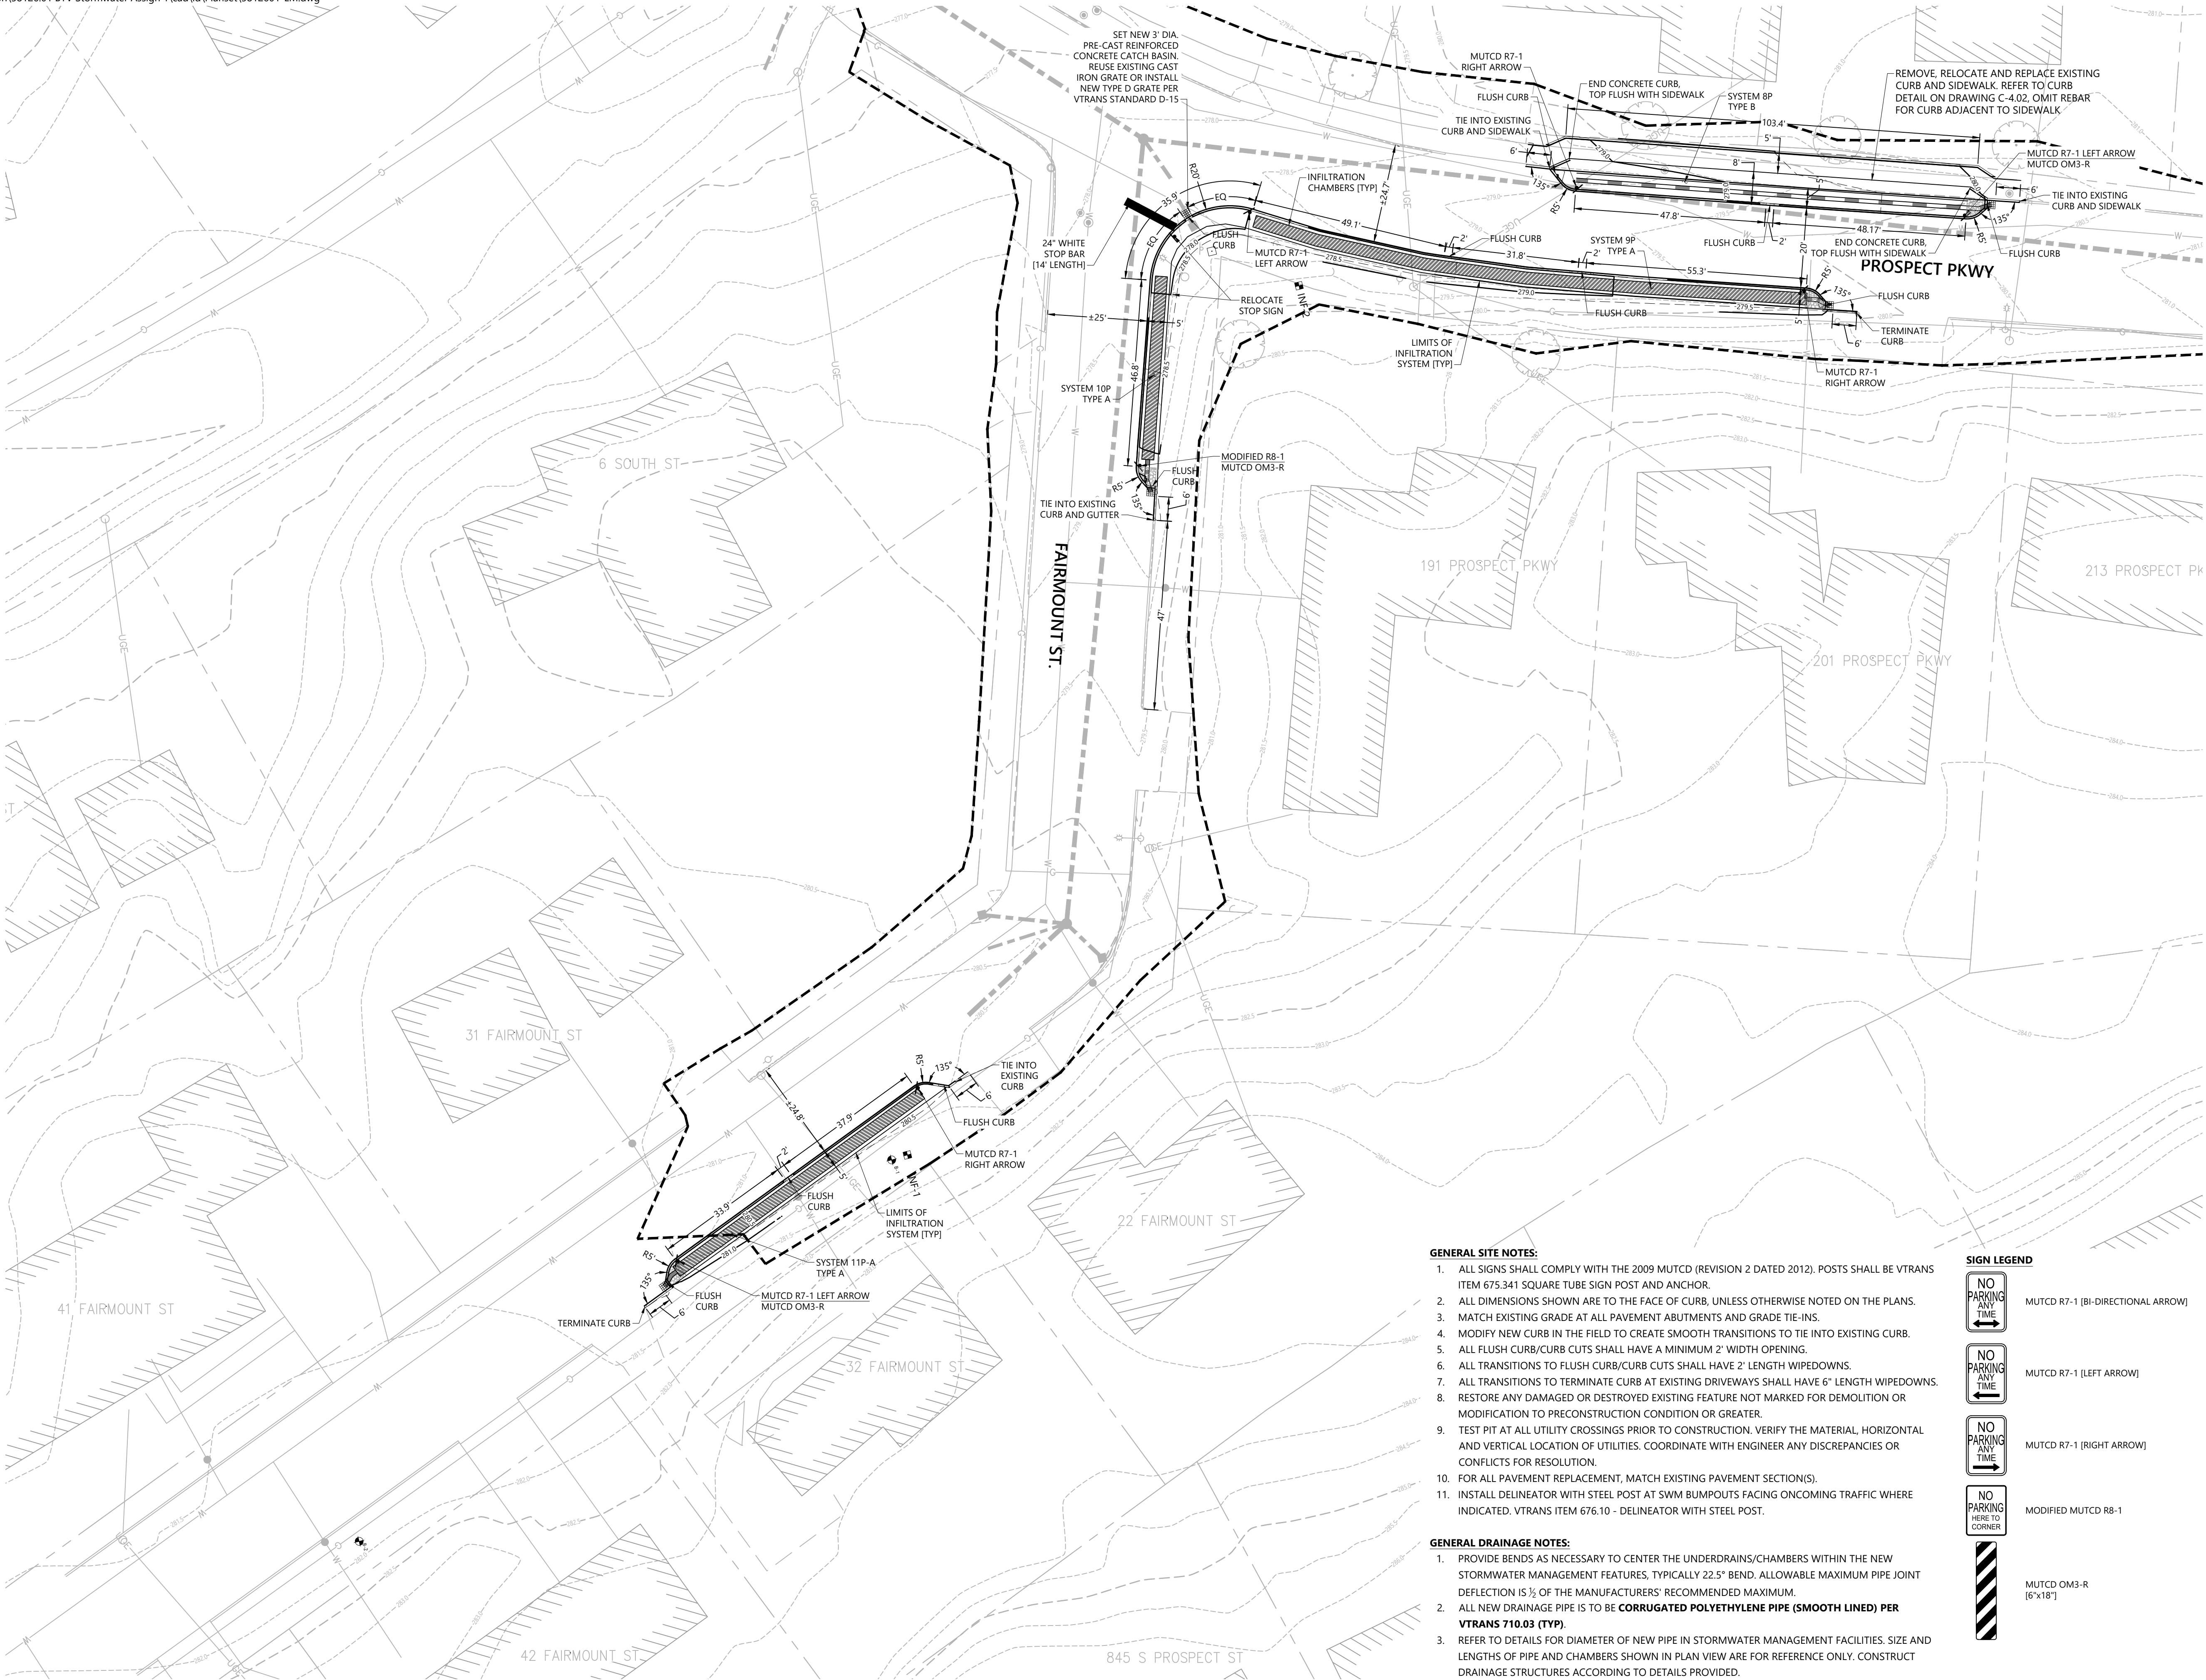

South End Retrofits
S. Prospect St. and Prospect Pky
Burlington, VT

No.	Revision	Date	Appvd.

Designed by	CHS	Checked by	NCH
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Issued for		Date	Dec. 10, 2020
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Bid

Layout and Materials Plan

STATE OF VERMONT
SEAL OF THE PROFESSION
NO. 133820
CIVIL
10 DECEMBER 2020
LICENSED PROFESSIONAL ENGINEER

C-3.03

Drawing Title

Sheet 15 of 24

Project Number
58126.01

GENERAL SITE NOTES:

1. ALL SIGNS SHALL COMPLY WITH THE 2009 MUTCD (REVISION 2 DATED 2012). POSTS SHALL BE VTRANS ITEM 675.341 SQUARE TUBE SIGN POST AND ANCHOR.
2. ALL DIMENSIONS SHOWN ARE TO THE FACE OF CURB, UNLESS OTHERWISE NOTED ON THE PLANS.
3. MATCH EXISTING GRADE AT ALL PAVEMENT ABUTMENTS AND GRADE TIE-INS.
4. MODIFY NEW CURB IN THE FIELD TO CREATE SMOOTH TRANSITIONS TO TIE INTO EXISTING CURB.
5. ALL FLUSH CURB/CURB CUTS SHALL HAVE A MINIMUM 2' WIDTH OPENING.
6. ALL TRANSITIONS TO FLUSH CURB/CURB CUTS SHALL HAVE 2' LENGTH WIPEDOWNS.
7. ALL TRANSITIONS TO TERMINATE CURB AT EXISTING DRIVEWAYS SHALL HAVE 6" LENGTH WIPEDOWNS.
8. RESTORE ANY DAMAGED OR DESTROYED EXISTING FEATURE NOT MARKED FOR DEMOLITION OR MODIFICATION TO PRECONSTRUCTION CONDITION OR GREATER.
9. TEST PIT AT ALL UTILITY CROSSINGS PRIOR TO CONSTRUCTION. VERIFY THE MATERIAL, HORIZONTAL AND VERTICAL LOCATION OF UTILITIES. COORDINATE WITH ENGINEER ANY DISCREPANCIES OR CONFLICTS FOR RESOLUTION.
10. FOR ALL PAVEMENT REPLACEMENT, MATCH EXISTING PAVEMENT SECTION(S).
11. INSTALL DELINEATOR WITH STEEL POST AT SWM BUMPOUTS FACING ONCOMING TRAFFIC WHERE INDICATED. VTRANS ITEM 676.10 - DELINEATOR WITH STEEL POST.

GENERAL DRAINAGE NOTES:

1. PROVIDE BENDS AS NECESSARY TO CENTER THE UNDERDRAINS/CHAMBERS WITHIN THE NEW STORMWATER MANAGEMENT FEATURES. TYPICALLY 22.5° BEND. ALLOWABLE MAXIMUM PIPE JOINT DEFLECTION IS 1/2 OF THE MANUFACTURERS' RECOMMENDED MAXIMUM.
2. ALL NEW DRAINAGE PIPE IS TO BE **CORRUGATED POLYETHYLENE PIPE (SMOOTH LINED) PER VTRANS 710.03 (TYP)**.
3. REFER TO DETAILS FOR DIAMETER OF NEW PIPE IN STORMWATER MANAGEMENT FACILITIES. SIZE AND LENGTHS OF PIPE AND CHAMBERS SHOWN IN PLAN VIEW ARE FOR REFERENCE ONLY. CONSTRUCT DRAINAGE STRUCTURES ACCORDING TO DETAILS PROVIDED.

SIGN LEGEND

- NO PARKING ANY TIME

MUTCD R7-1 [BI-DIRECTIONAL ARROW]

NO PARKING ANY TIME

MUTCD R7-1 [LEFT ARROW]

NO PARKING ANY TIME

MUTCD R7-1 [RIGHT ARROW]


NO PARKING HERE TO CORNER

MODIFIED MUTCD R8-1

MUTCD OM3-R [6'x18']



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South End Retrofits
S. Prospect St. and Prospect Pky
Burlington, VT

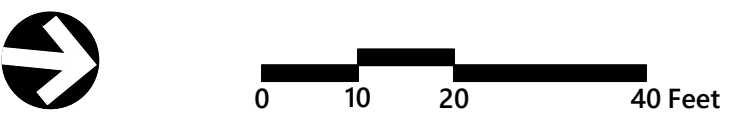No.	Revision	Date	Apprvd.
1	Street Name Revision	1/19/21	NCH

Designed by	CHS	Checked by	NCH
Issued for		Date	

Bid Dec. 10, 2020

Layout and Materials Plan

Drawing Title

Drawing Number

C-3.04

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Project Number 58126.01

Professional Engineer Seal: State of Vermont, No. 133820, Civil, 10 December 2020

GENERAL SITE NOTES:


1. ALL SIGNS SHALL COMPLY WITH THE 2009 MUTCD (REVISION 2 DATED 2012), POSTS SHALL BE VTRANS ITEM 675.341 SQUARE TUBE SIGN POST AND ANCHOR.
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11. INSTALL DELINEATOR WITH STEEL POST AT SWM BUMPOUTS FACING ONCOMING TRAFFIC WHERE INDICATED. VTRANS ITEM 676.10 - DELINEATOR WITH STEEL POST.

GENERAL DRAINAGE NOTES:

1. PROVIDE BENDS AS NECESSARY TO CENTER THE UNDERDRAINS/CHAMBERS WITHIN THE NEW STORMWATER MANAGEMENT FEATURES, TYPICALLY 22.5° BEND. ALLOWABLE MAXIMUM PIPE JOINT DEFLECTION IS 1/2 OF THE MANUFACTURERS' RECOMMENDED MAXIMUM.
2. ALL NEW DRAINAGE PIPE IS TO BE **CORRUGATED POLYETHYLENE PIPE (SMOOTH LINED) PER VTRANS 710.03 (TYP)**.
3. REFER TO DETAILS FOR DIAMETER OF NEW PIPE IN STORMWATER MANAGEMENT FACILITIES. SIZE AND LENGTHS OF PIPE AND CHAMBERS SHOWN IN PLAN VIEW ARE FOR REFERENCE ONLY. CONSTRUCT DRAINAGE STRUCTURES ACCORDING TO DETAILS PROVIDED.


SIGN LEGEND

- | | |
|--|-----------------------------------|
| | MUTCD R7-1 [BI-DIRECTIONAL ARROW] |
| | MUTCD R7-1 (LEFT ARROW) |
| | MUTCD R7-1 (RIGHT ARROW) |
| | MODIFIED MUTCD R8-1 |
| | MUTCD OM3-R [6"x18"] |

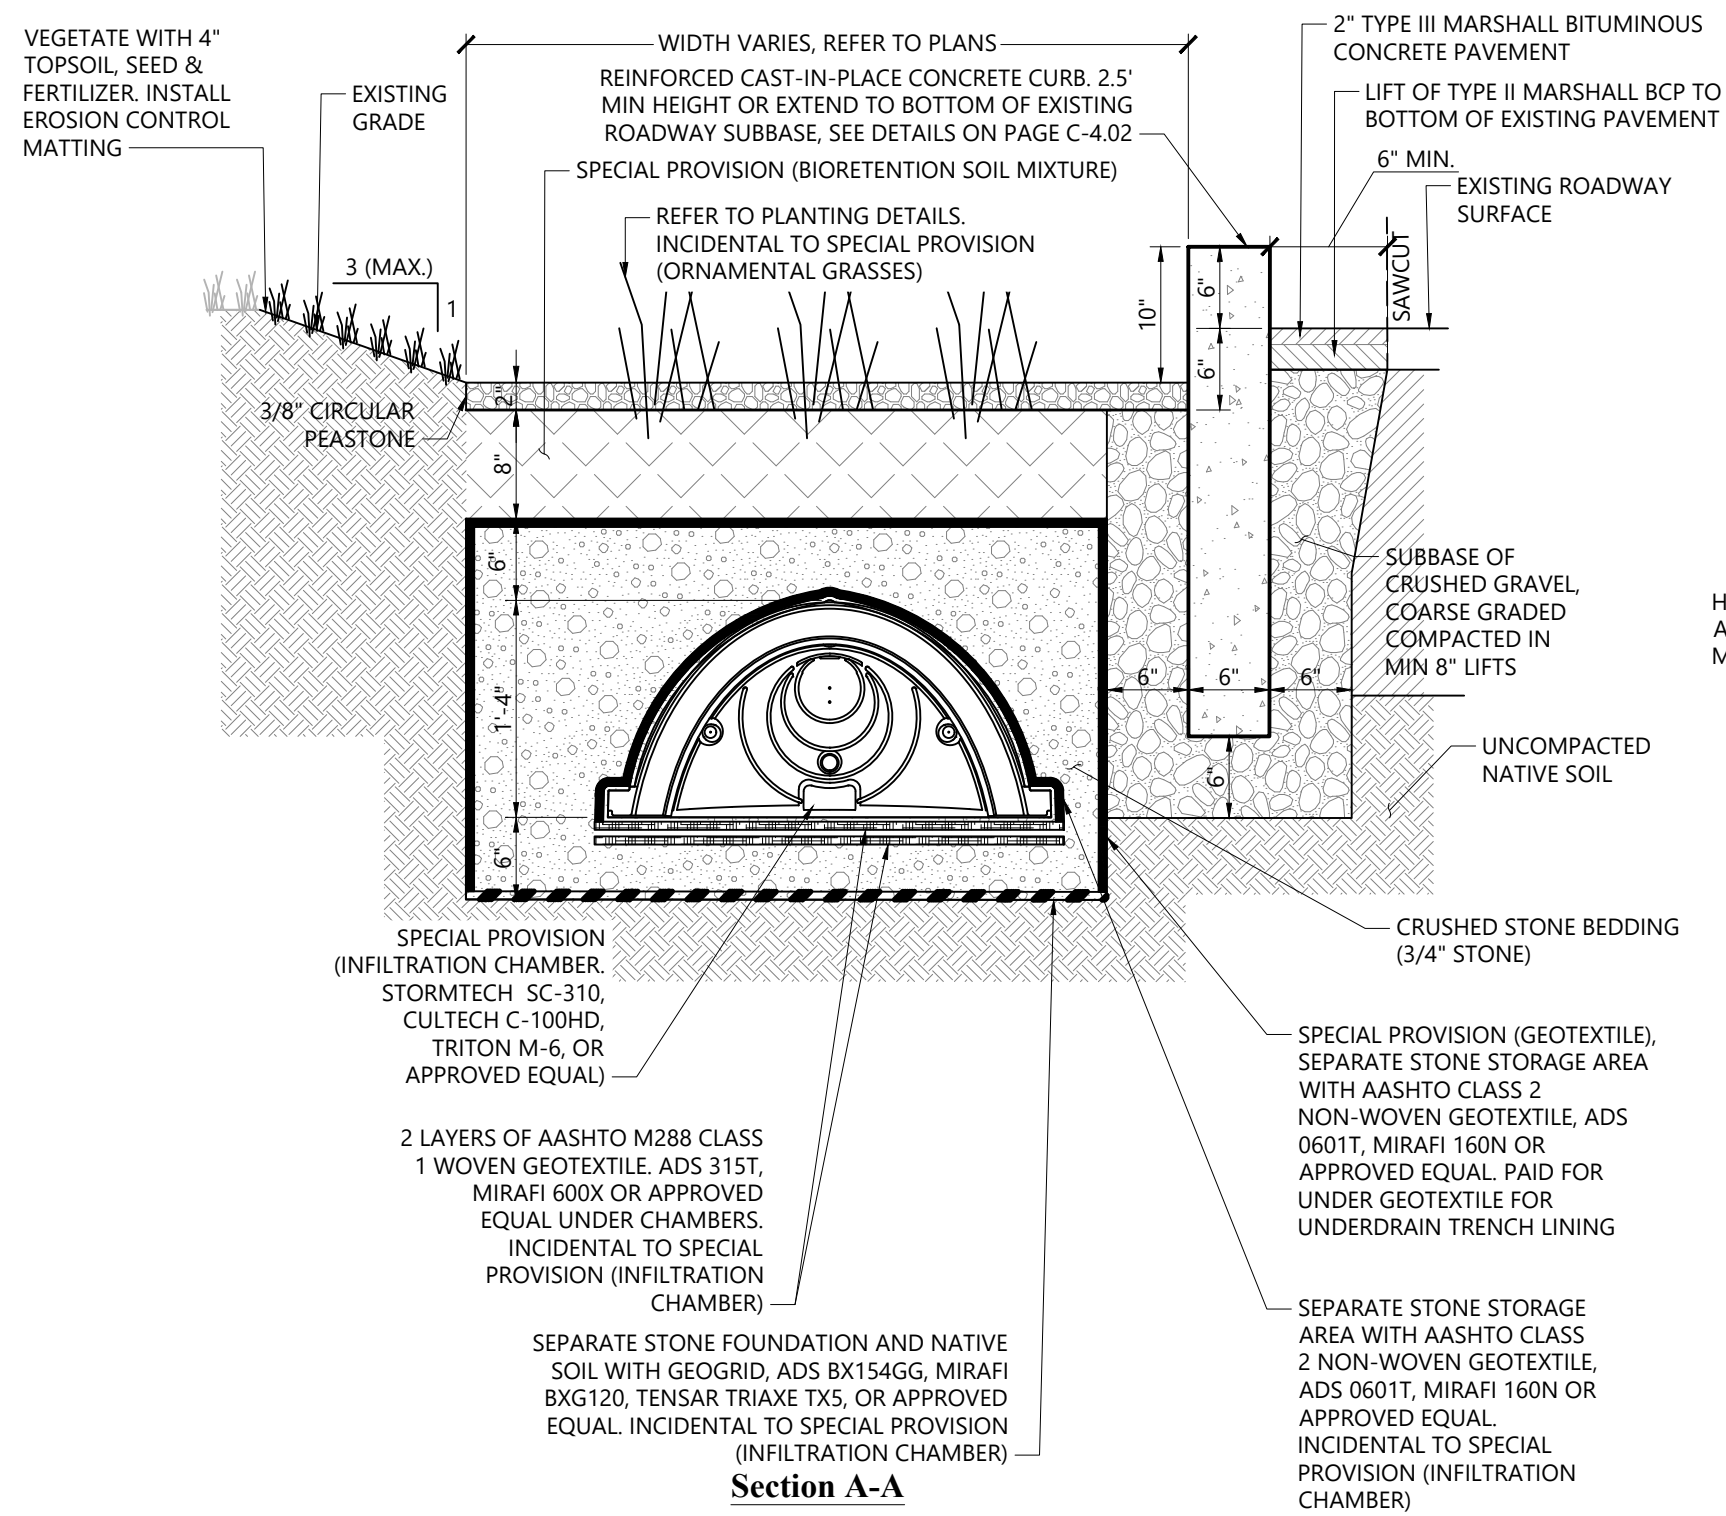


Bioretention Bumpout Section w/ Infiltration Chamber (Type A)

N.T.S.	Source: VHB	REV	LD_
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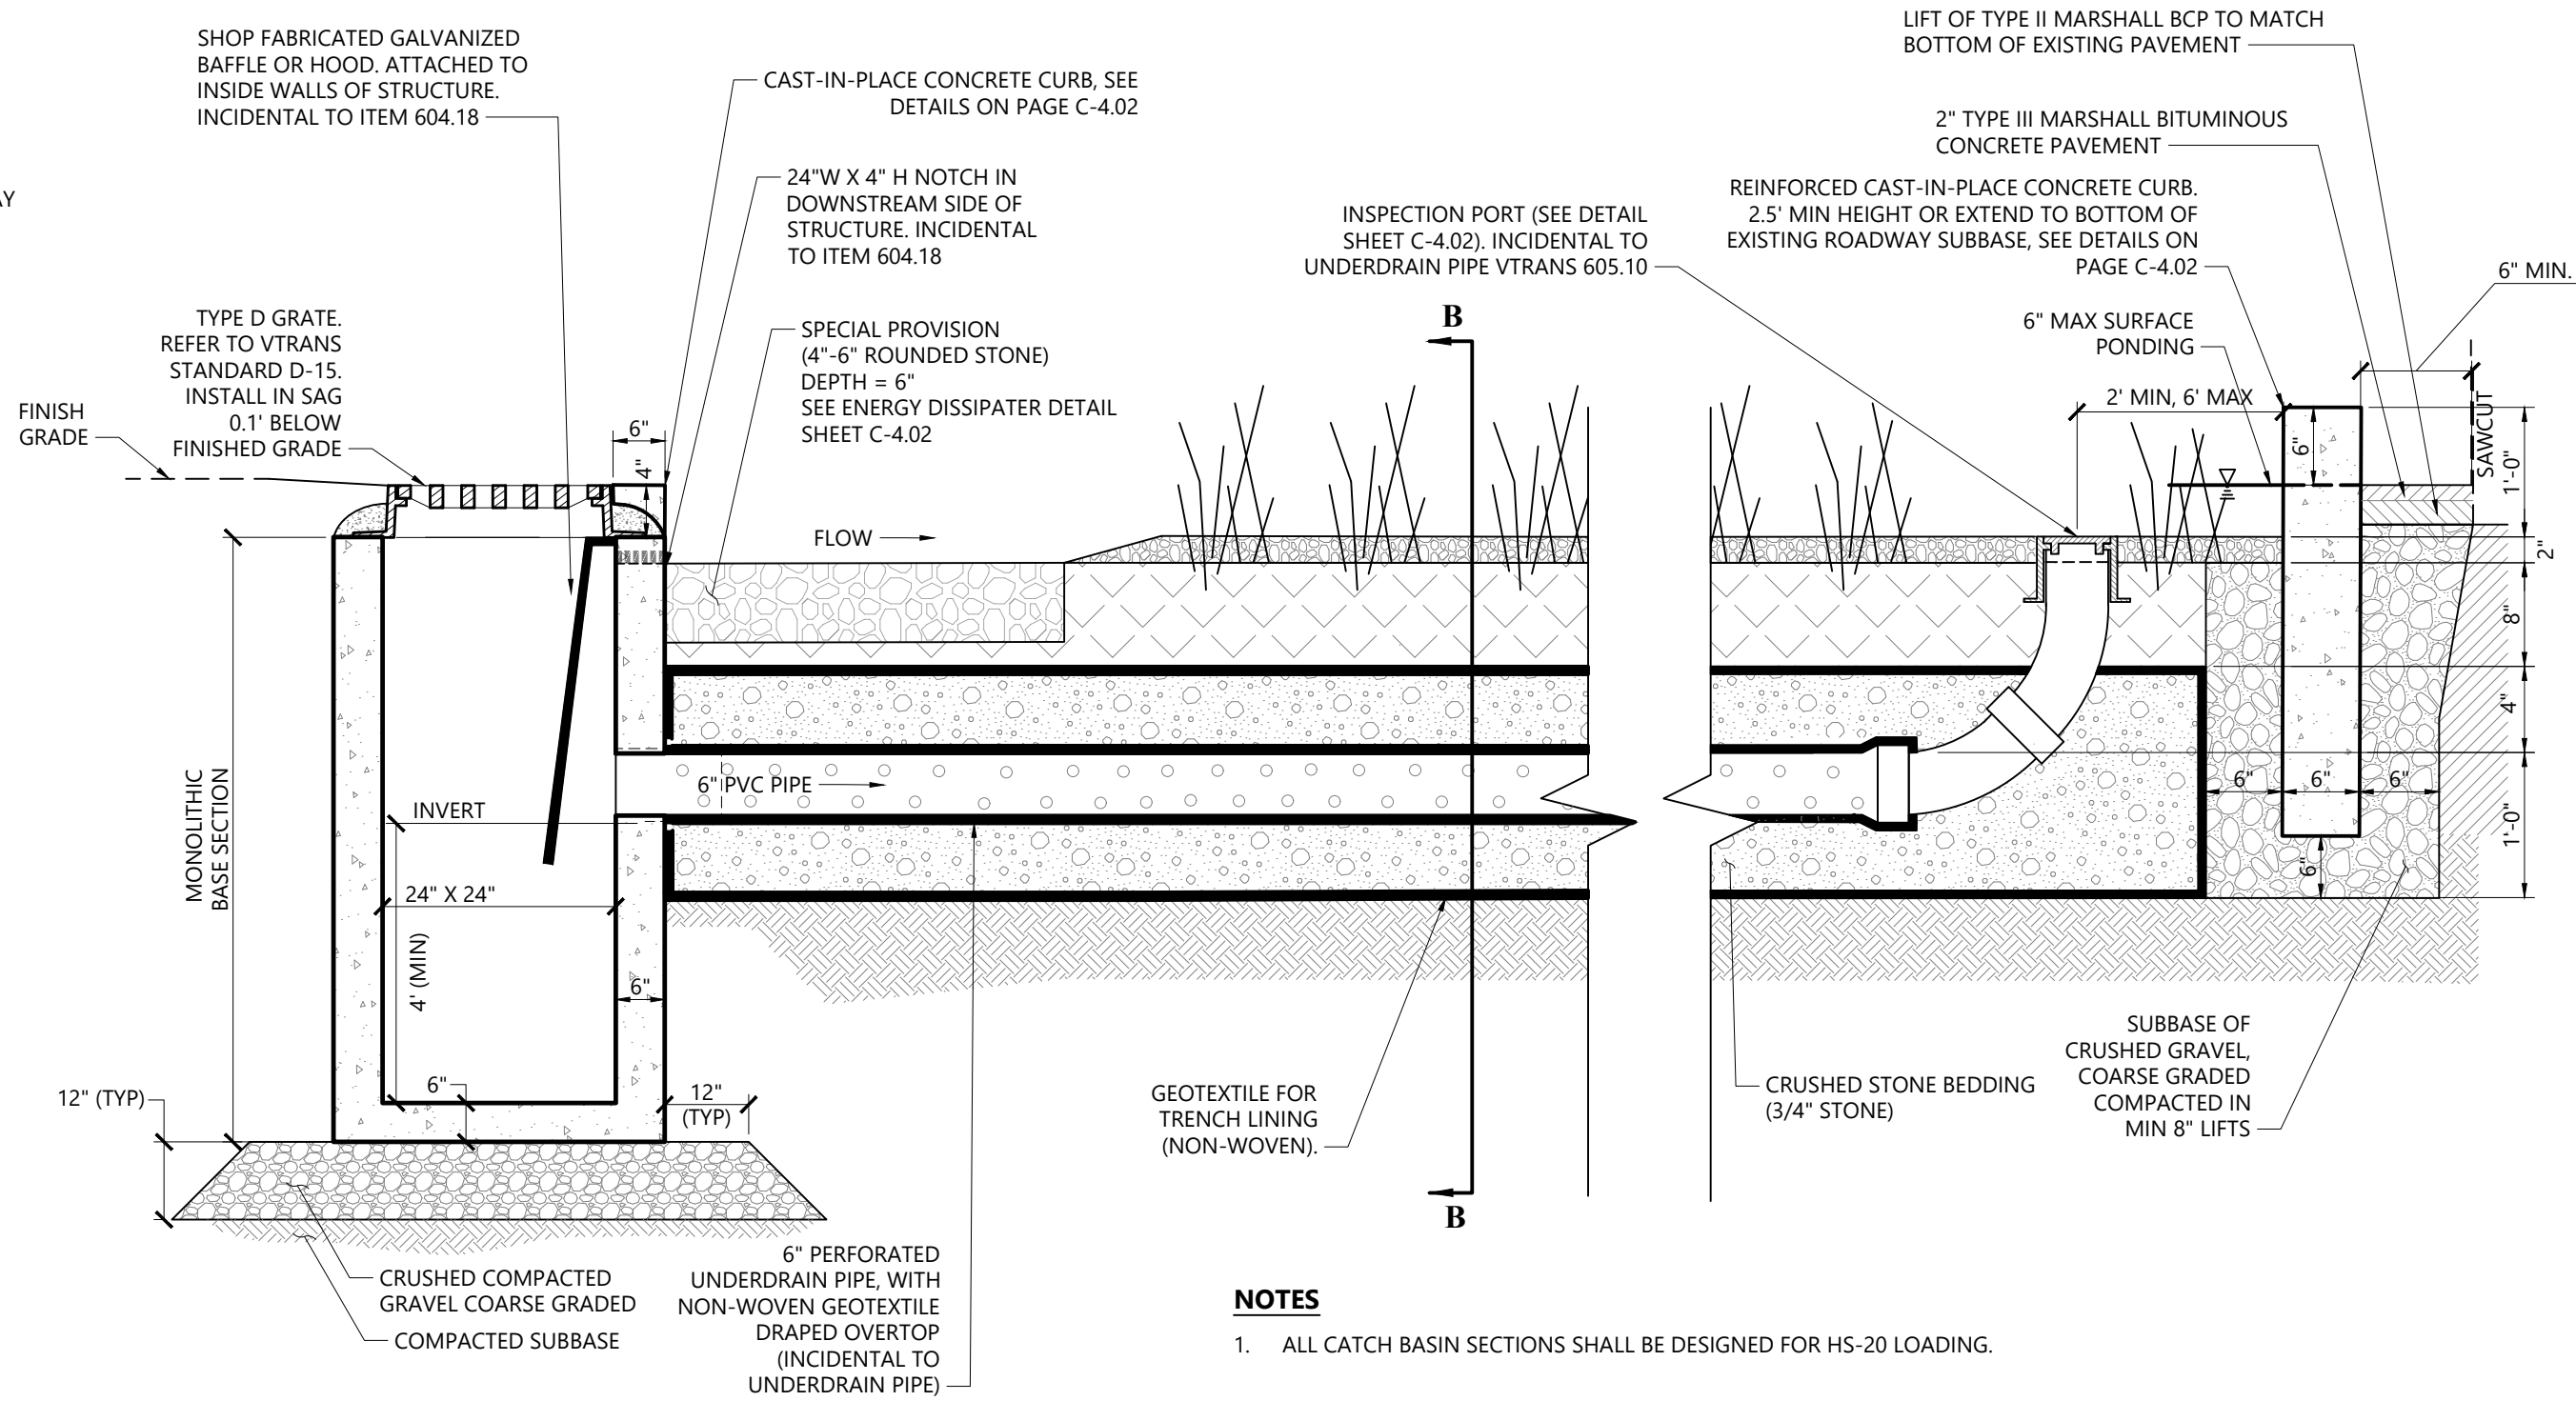
Typical Profile - Bioretention Bumpout (Type A)

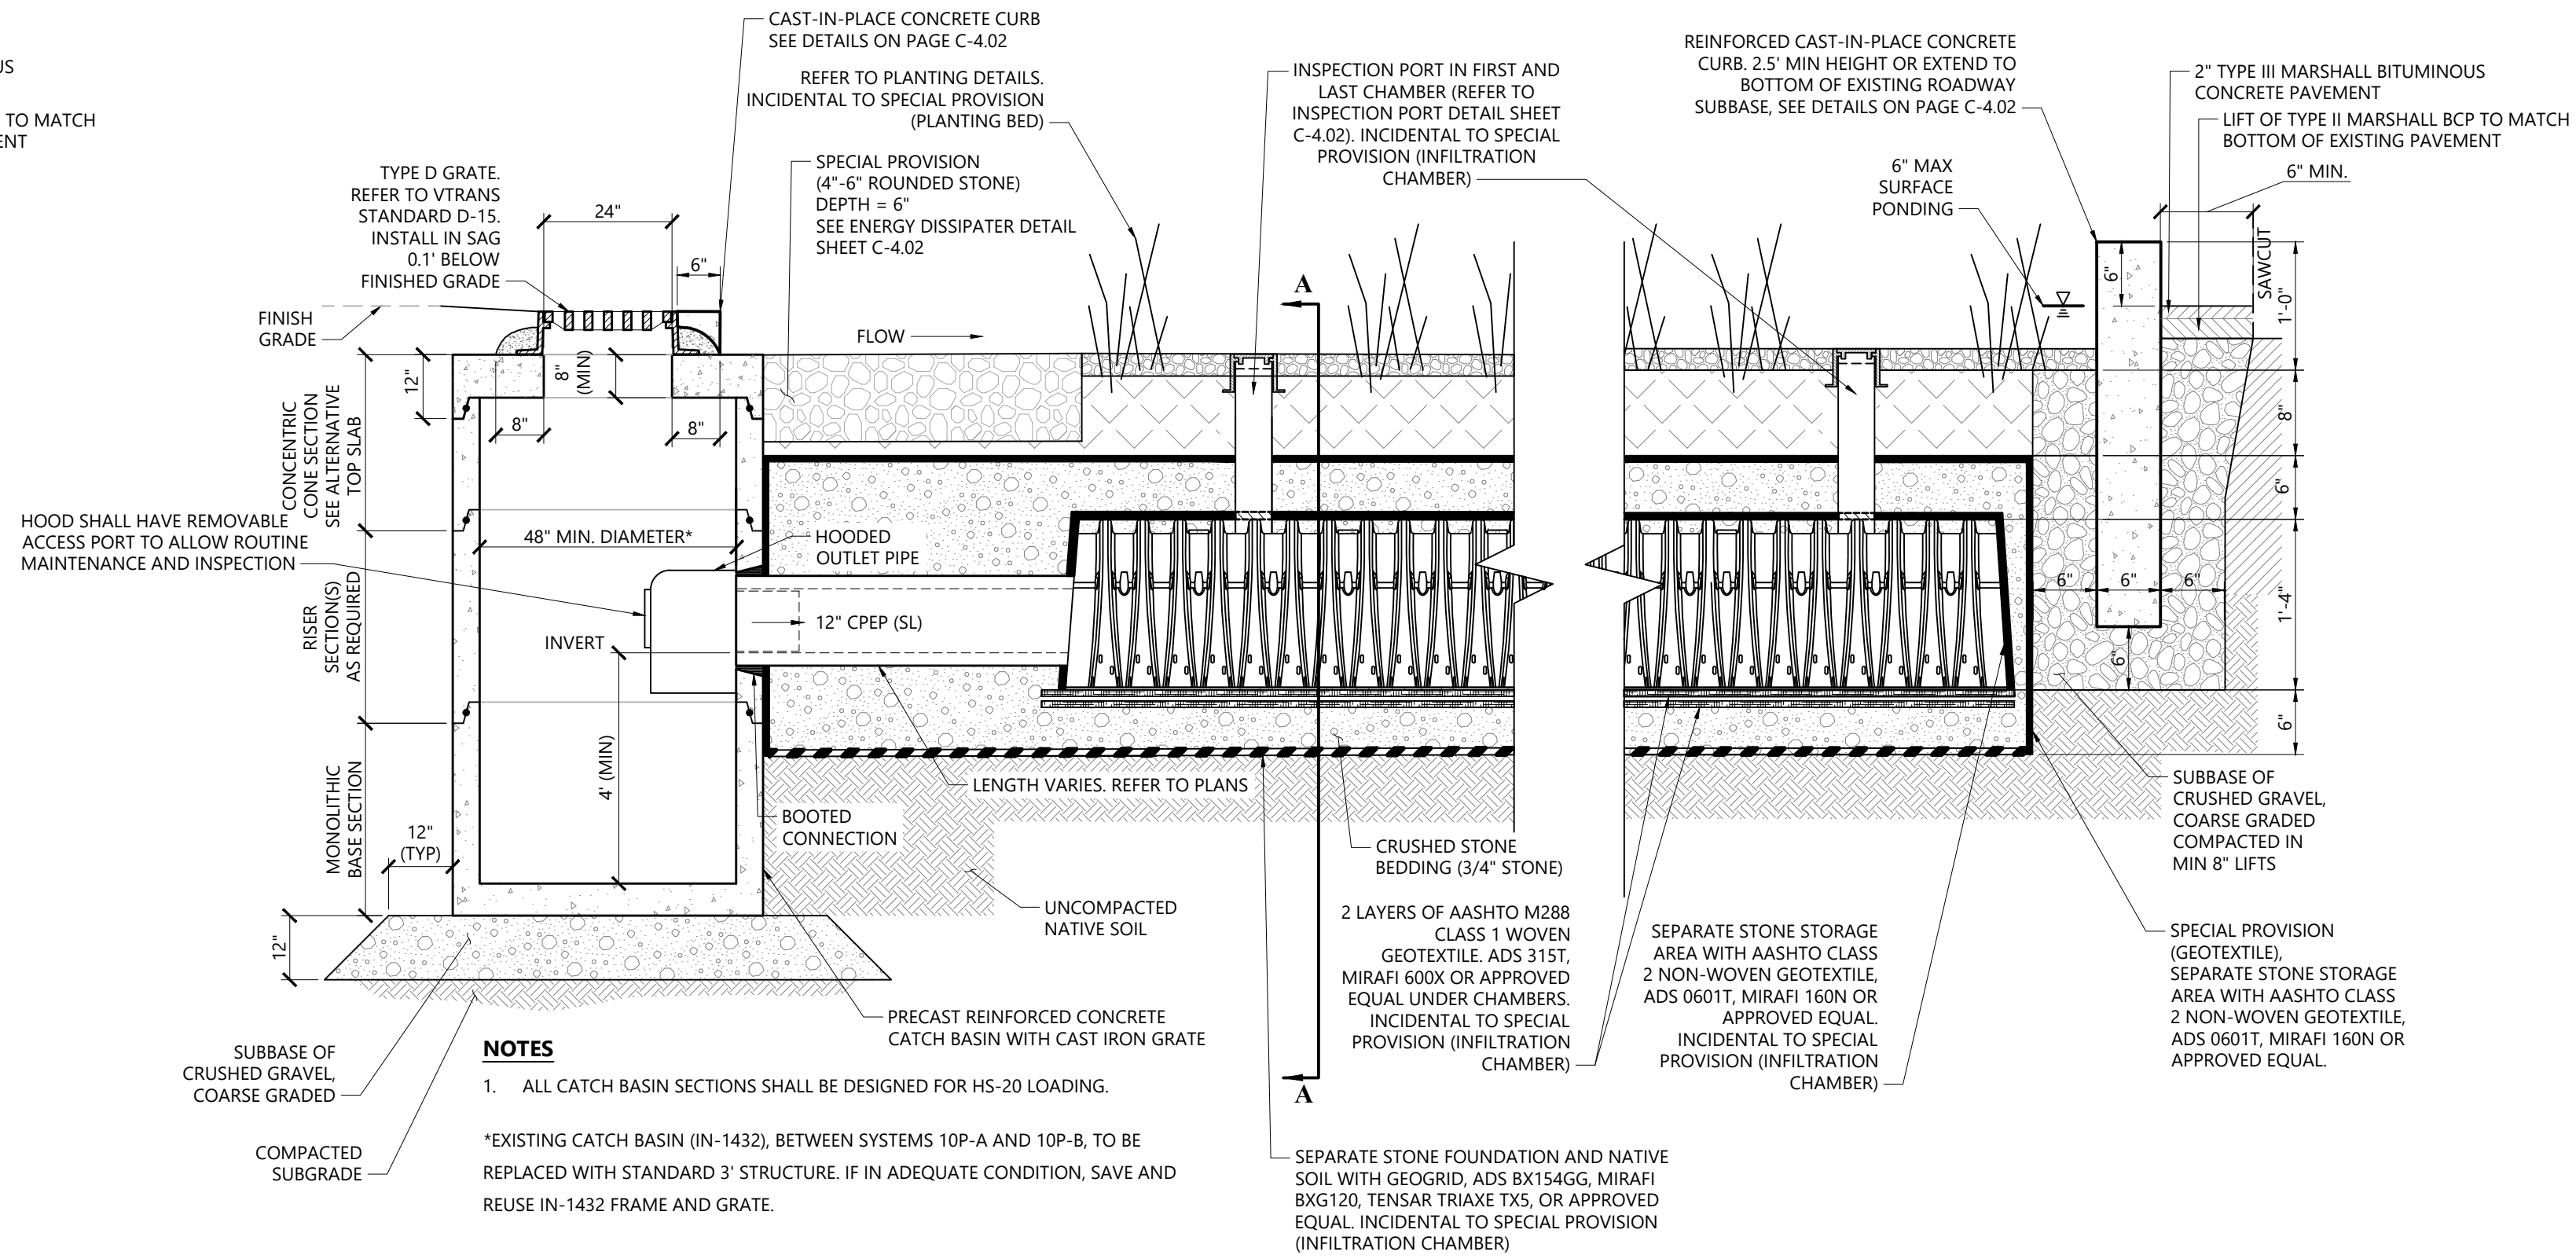N.T.S.	Source: VHB	LD
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Bioretention Bumpout Section w/o Infiltration Chamber (Type B)

N.T.S. Source: VHB REV LD_

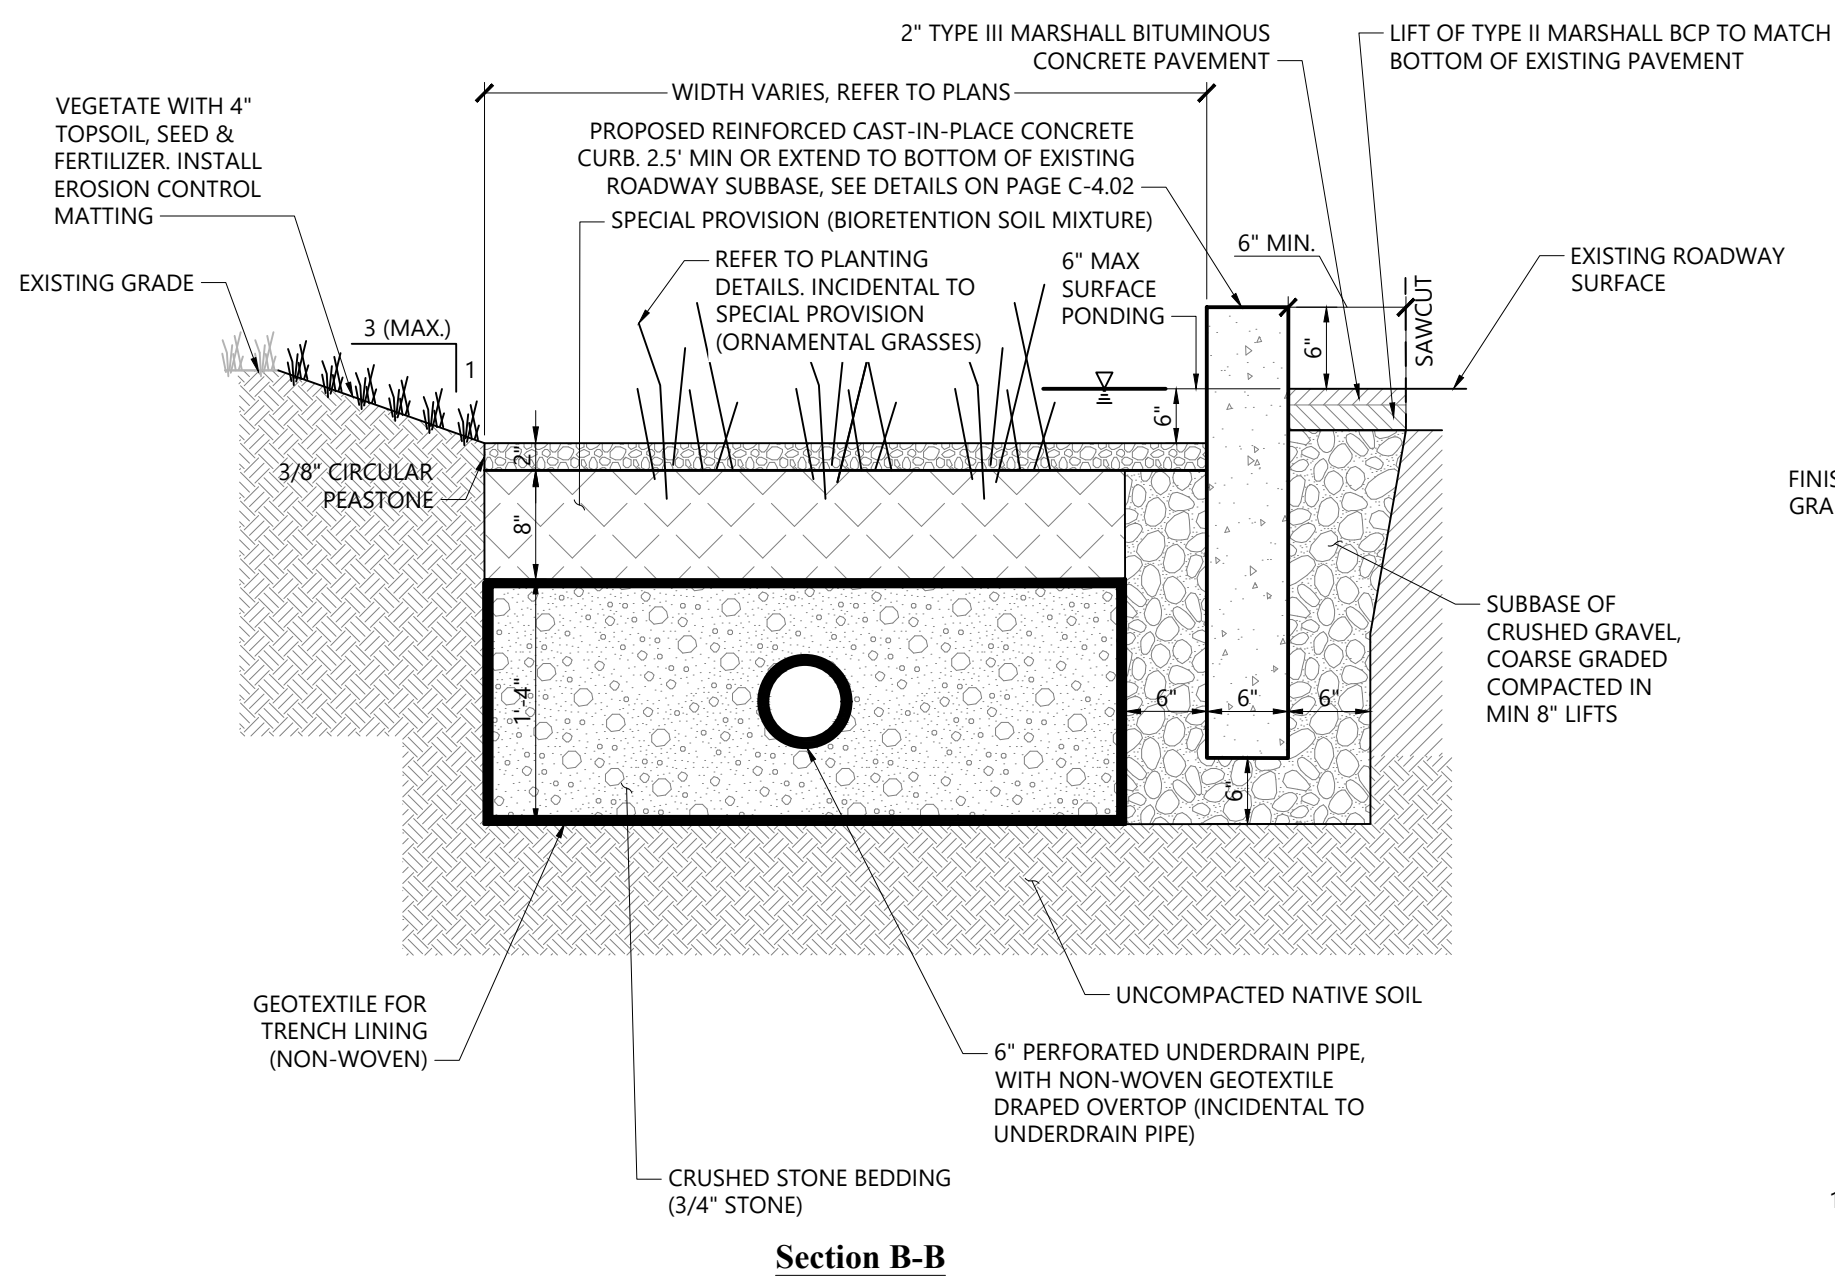

Typical Profile - Bioretention Bumpout (Type B)

N.T.S. Source: VHB LD_



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South End Retrofits


S. Prospect St. and Prospect Pky
Burlington, VT

No.	Revision	Date	Appvd.
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Designed by	CHS	Checked by	PBS
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Issued for	Date
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Site Details 1




Drawing Number


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Project Number
58126.01

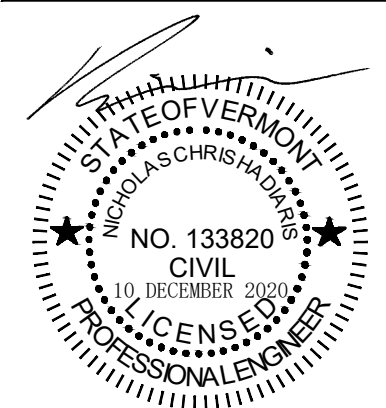


Wipedown Detail 2/20
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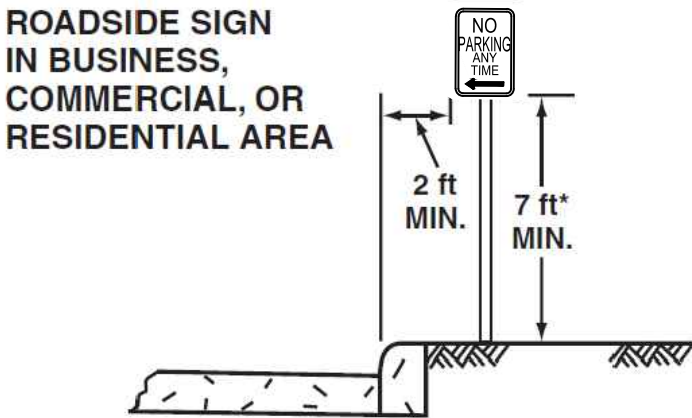


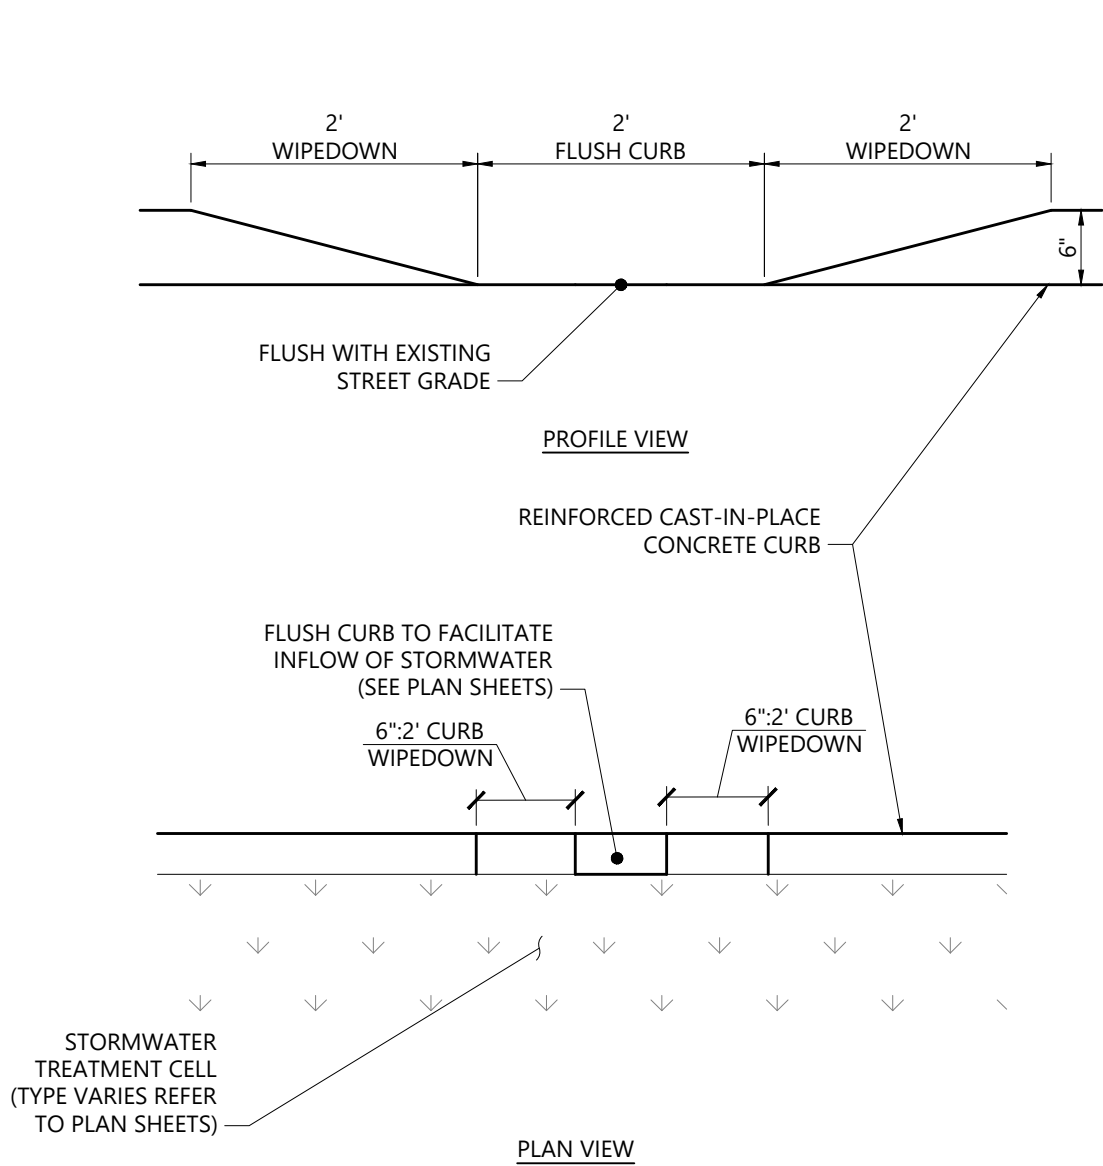- NOTES:**
1. SPECIAL PROVISION (REINFORCED CAST-IN-PLACE CONCRETE CURB).
 2. CONCRETE CURB SHALL COMPLY WITH ALL RELEVANT SECTIONS OF THE VTRANS 2018 STANDARD SPECIFICATIONS FOR CONSTRUCTION.
 3. ENSURE 2" MINIMUM CLEARANCE FROM FACE OF CONCRETE TO EDGE OF REINFORCING STEEL.

Reinforced Cast-In-Place Curb 12/19
N.T.S. Source: VHB LD_

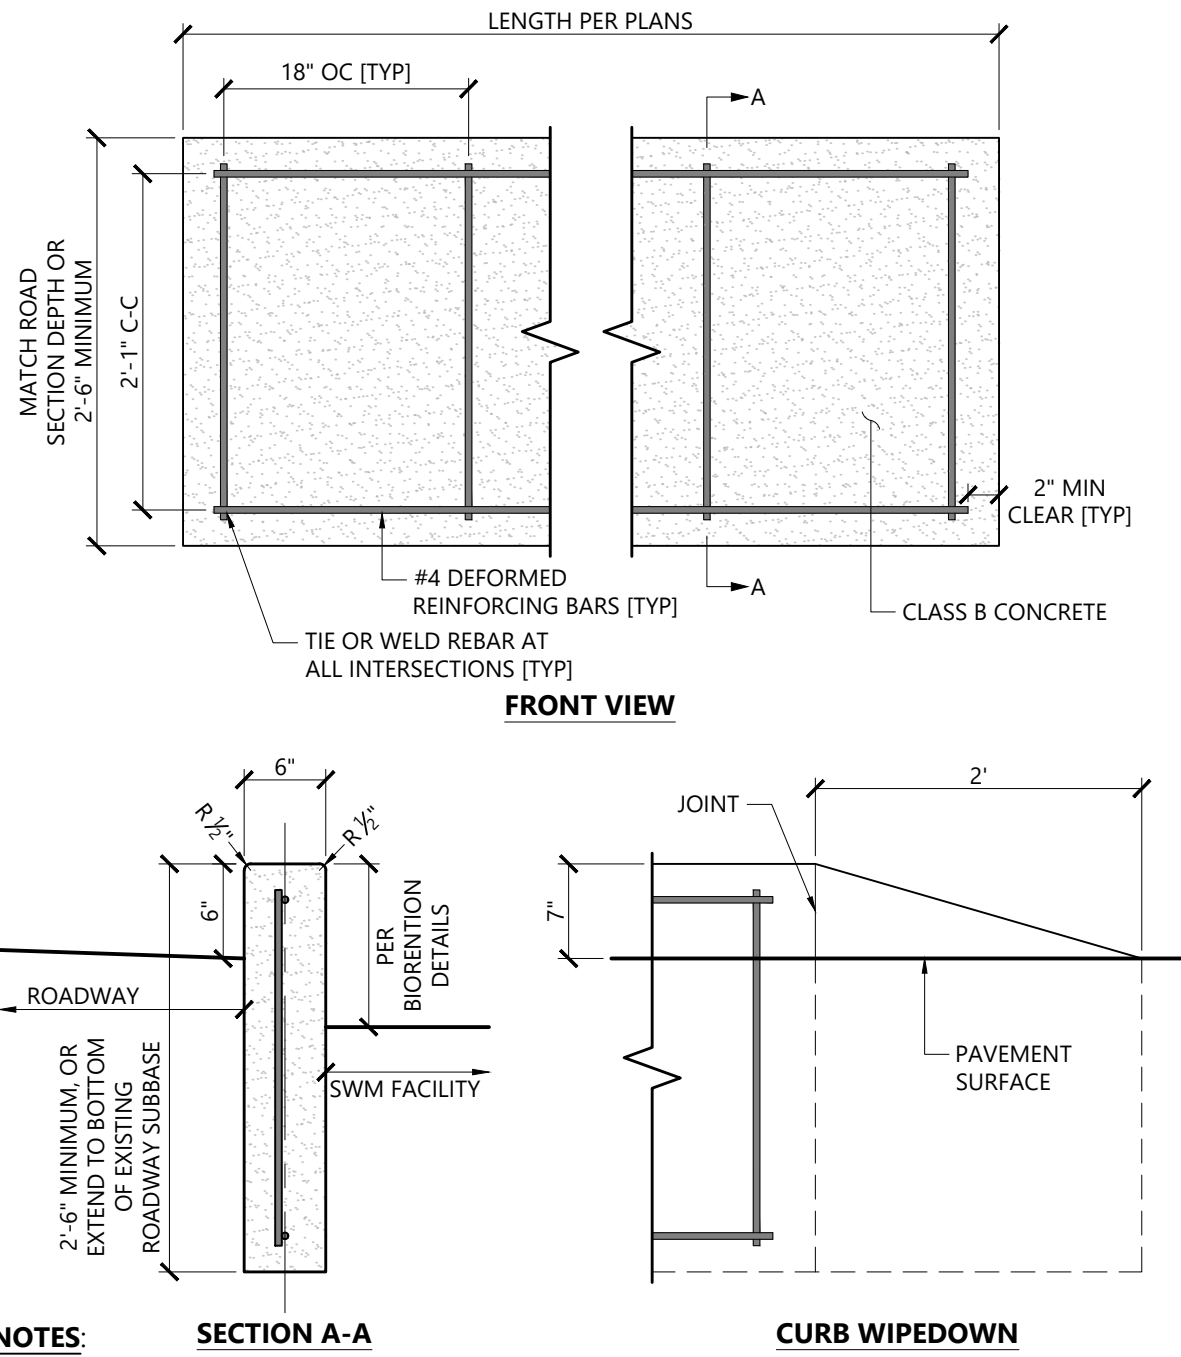


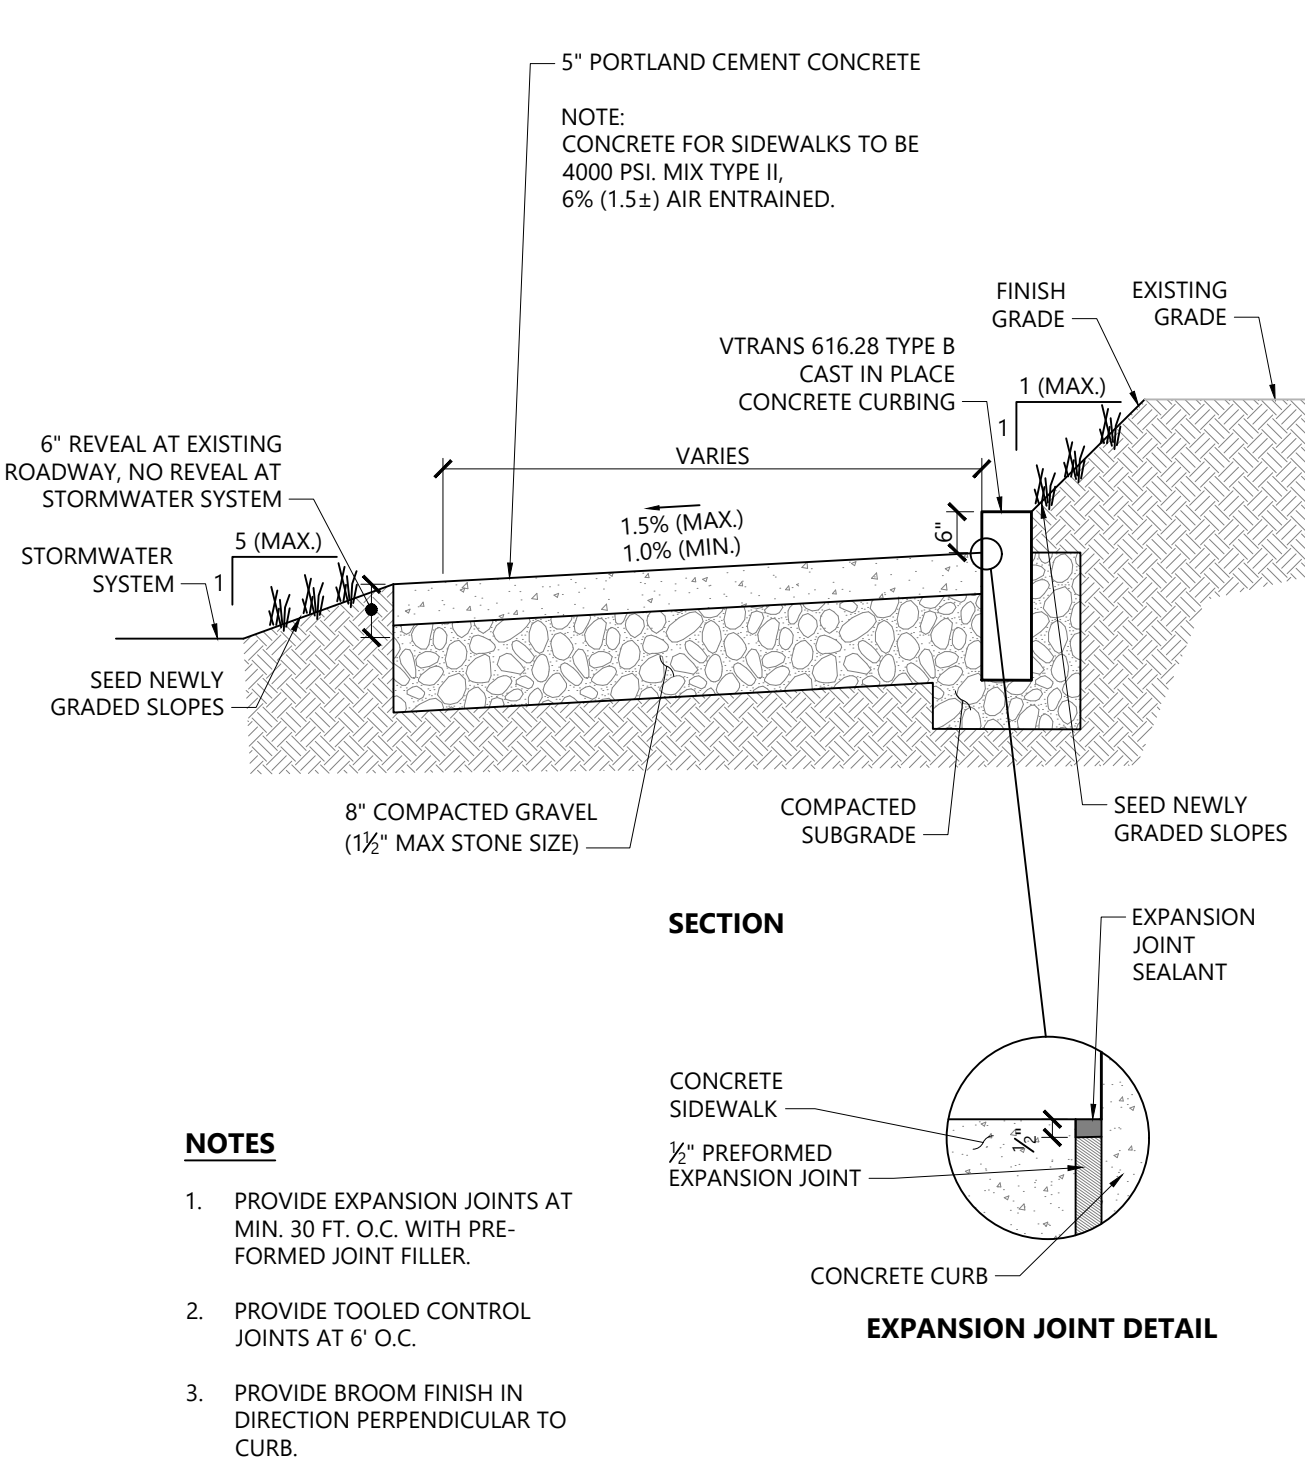Concrete Sidewalk At System 8P 2/20
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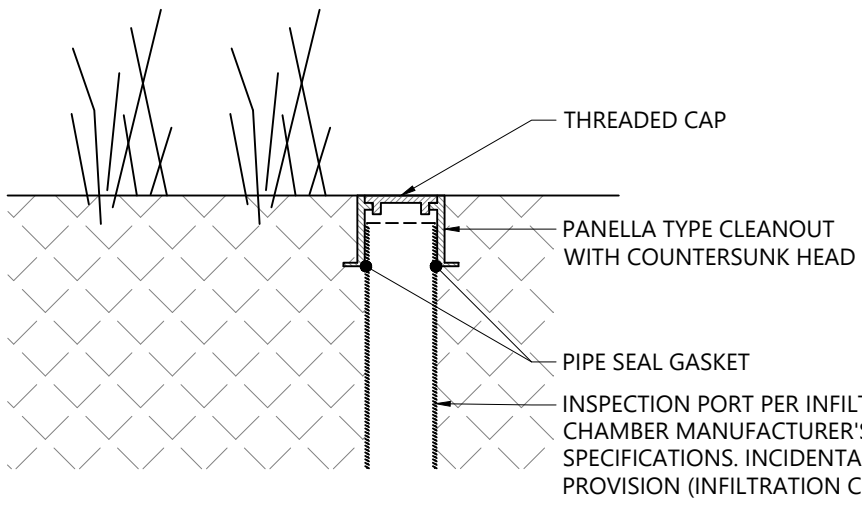


*Where parking or pedestrian movements are likely to occur


Sign Installation Guidelines
N.T.S. Source: MUTCD LD_

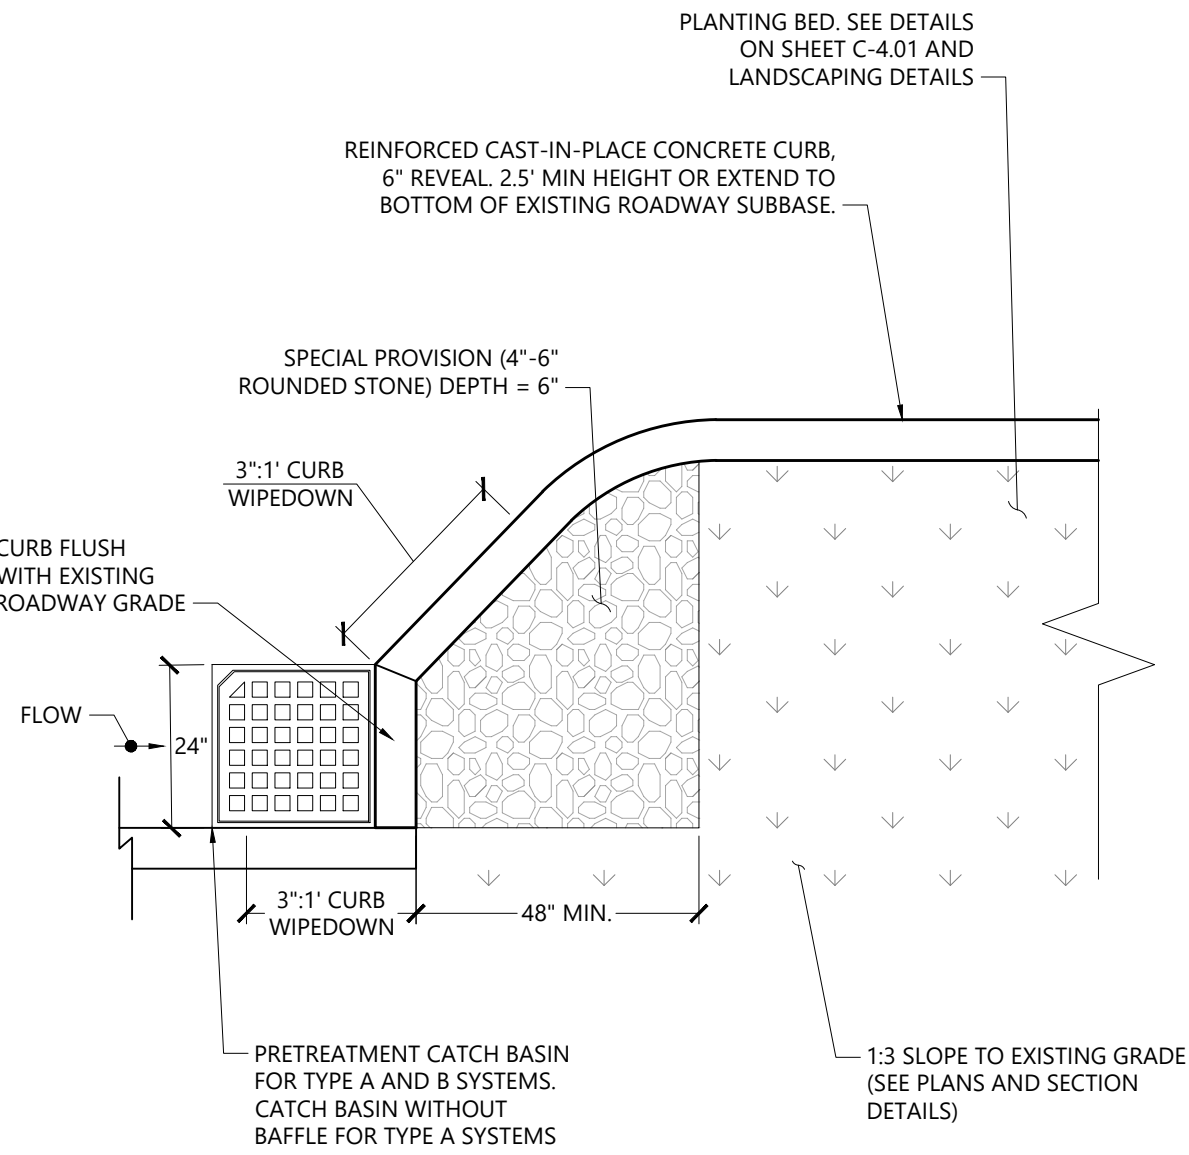

Stone Energy Dissipater 1/17
N.T.S. Source: VHB LD_



Inspection Port 1/17
N.T.S. Source: VHB LD_

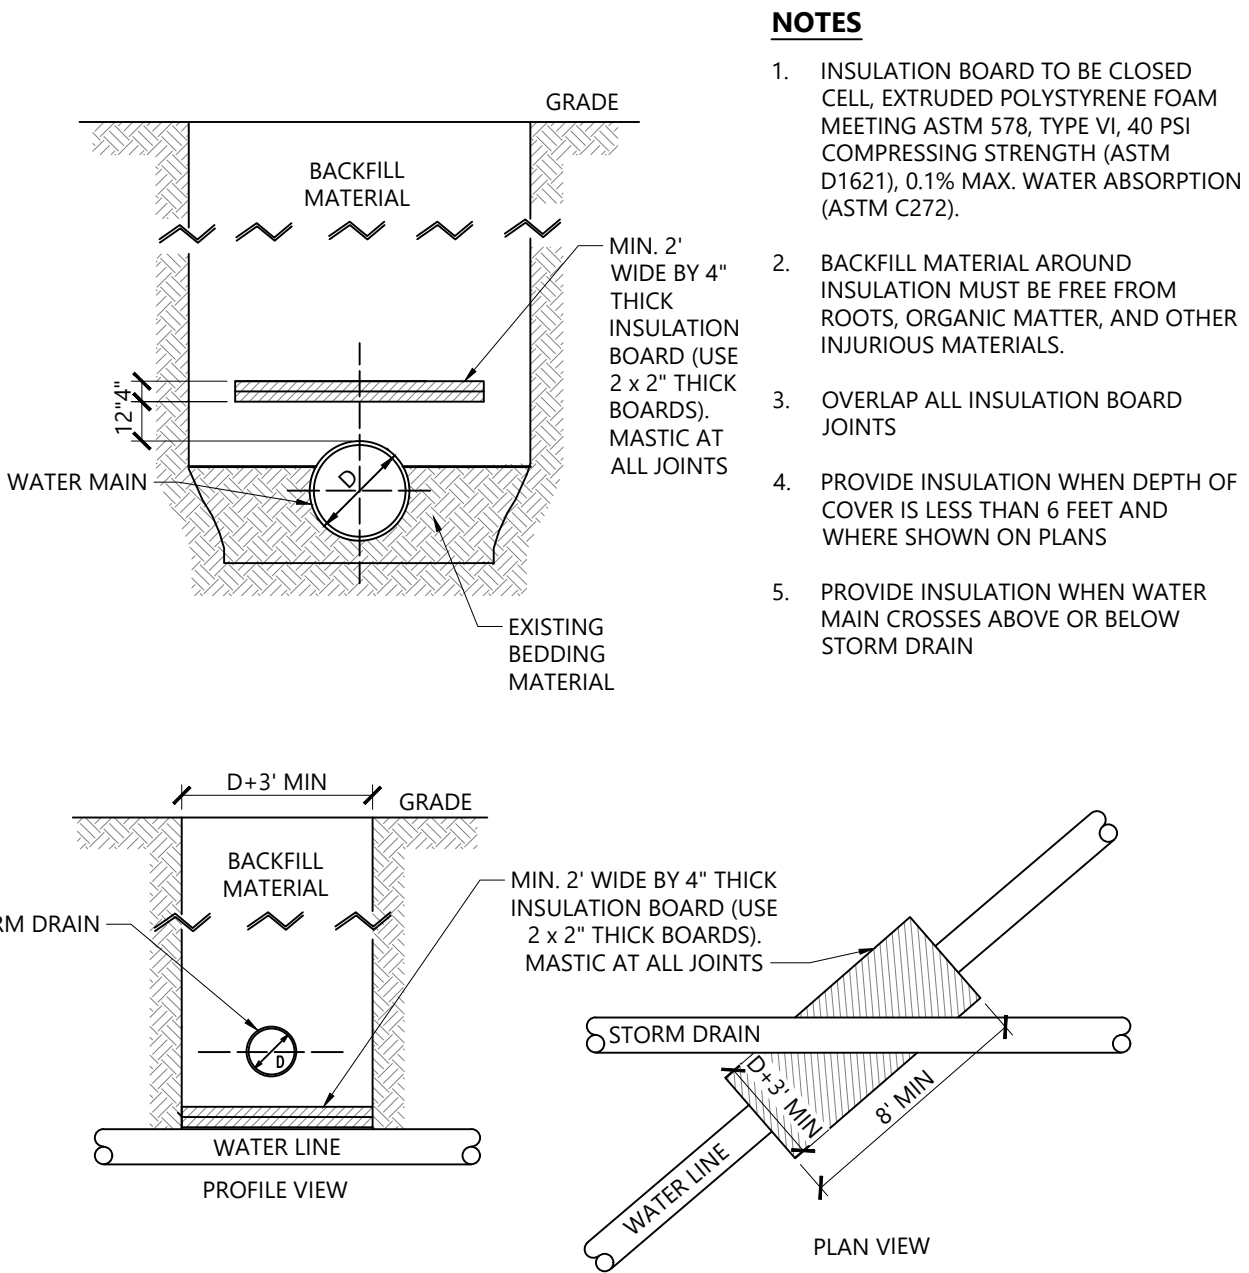

Water Line Isulation 12/19
N.T.S. Source: VHB LD_

South End Retrofits

S. Prospect St. and Prospect Pky
Burlington, VT

No.	Revision	Date	Appvd.

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Issued for		Date	Dec. 10, 2020

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Site Details 2

Drawing Number

C-4.02

Sheet 18 of 24

Project Number 58126.01

10 DECEMBER 2020

CIVIL

PROFESSIONAL ENGINEER

NO. 133820

STATE OF VERMONT

CHRISTOPHER J. CHASE




South End Retrofits
S. Prospect St. and Prospect Pky
Burlington, VT

No.	Revision	Date	Appd.

Designed by	MKW	Checked by	MKW
Issued for	Bid	Date	Dec. 10, 2020


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Overall Planting Plan



L-1.00


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Project Number
58126.01

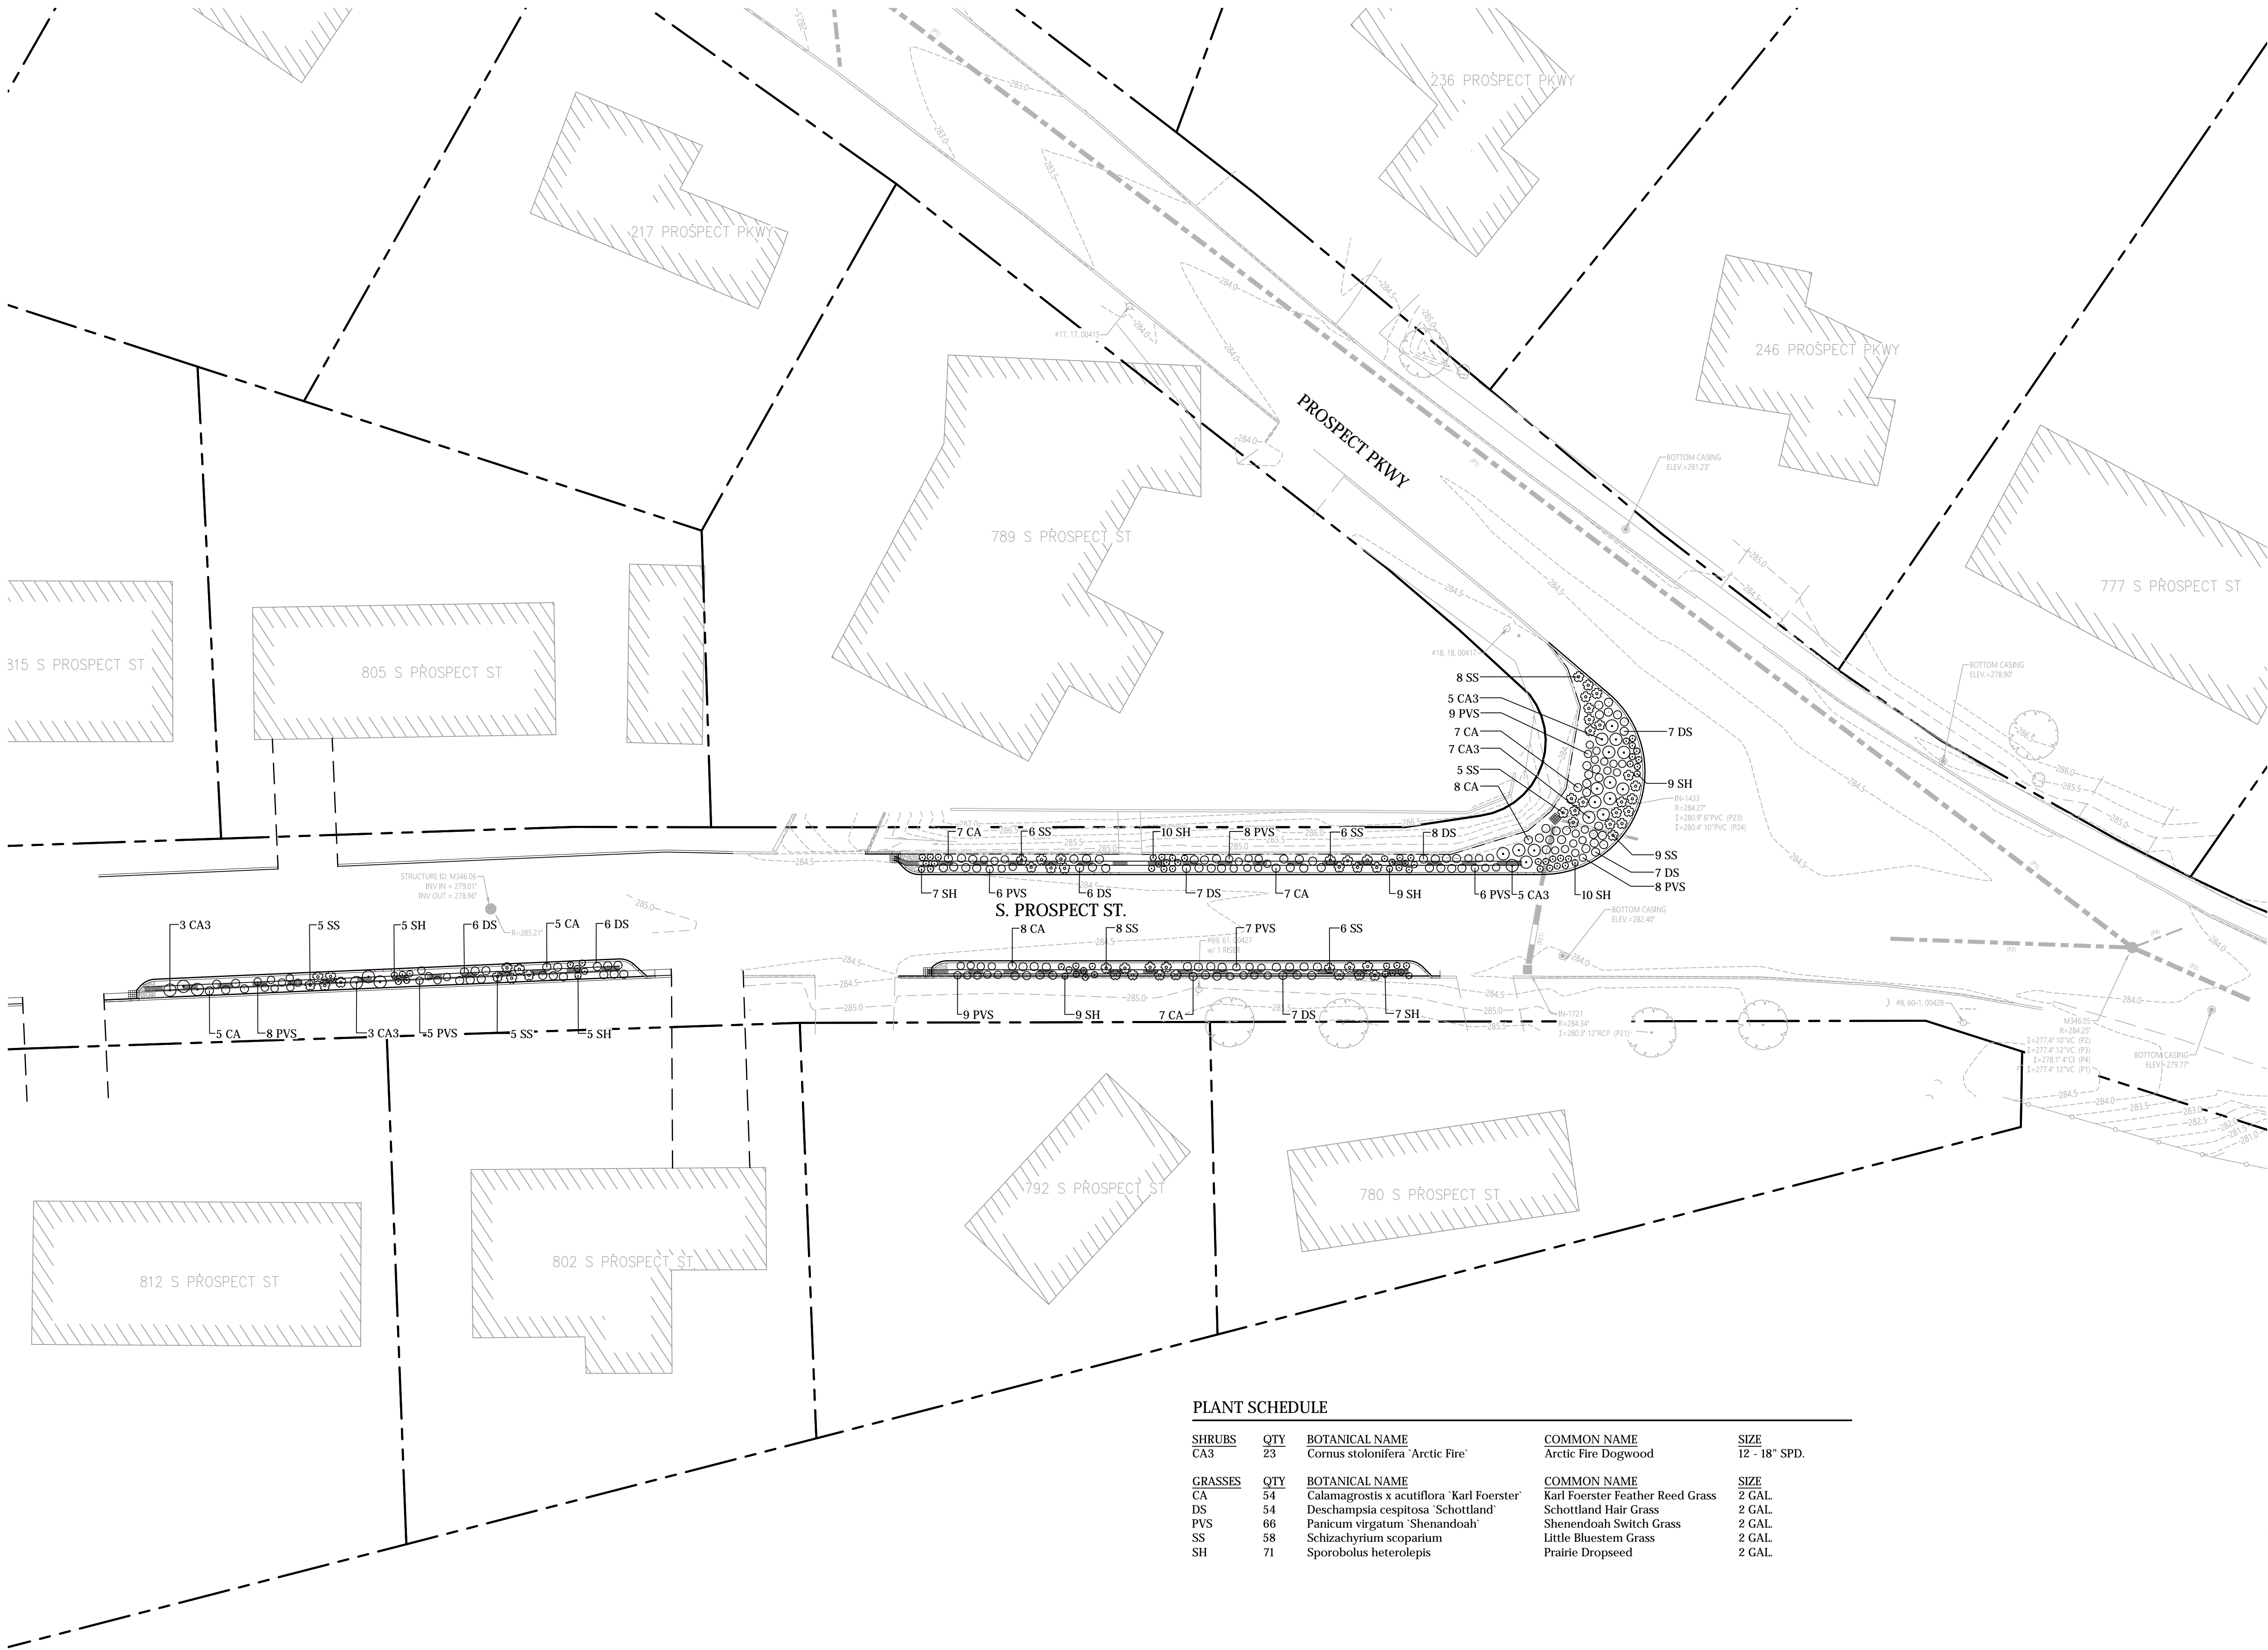

PLANT SCHEDULE

SHRUBS	QTY	BOTANICAL NAME	COMMON NAME	SIZE
CA3	23	Cornus stolonifera 'Arctic Fire'	Arctic Fire Dogwood	12 - 18" SPD.
GRASSES	QTY	BOTANICAL NAME	COMMON NAME	SIZE
CA	54	Calamagrostis x acutiflora 'Karl Foerster'	Karl Foerster Feather Reed Grass	2 GAL.
DS	54	Deschampsia cespitosa 'Schottland'	Schottland Hair Grass	2 GAL.
PVS	66	Panicum virgatum 'Shenandoah'	Shenandoah Switch Grass	2 GAL.
SS	58	Schizachyrium scoparium	Little Bluestem Grass	2 GAL.
SH	71	Sporobolus heterolepis	Prairie Dropseed	2 GAL.

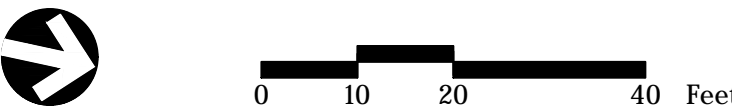


South End Retrofits
S. Prospect St. and Prospect Pky
Burlington, VT

No.	Revision	Date	Appd.


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Issued for	Bid	Date	Dec. 10, 2020

Drawing Title
Planting Plan

Drawing Number

 L-1.01

Sheet 20 of 24

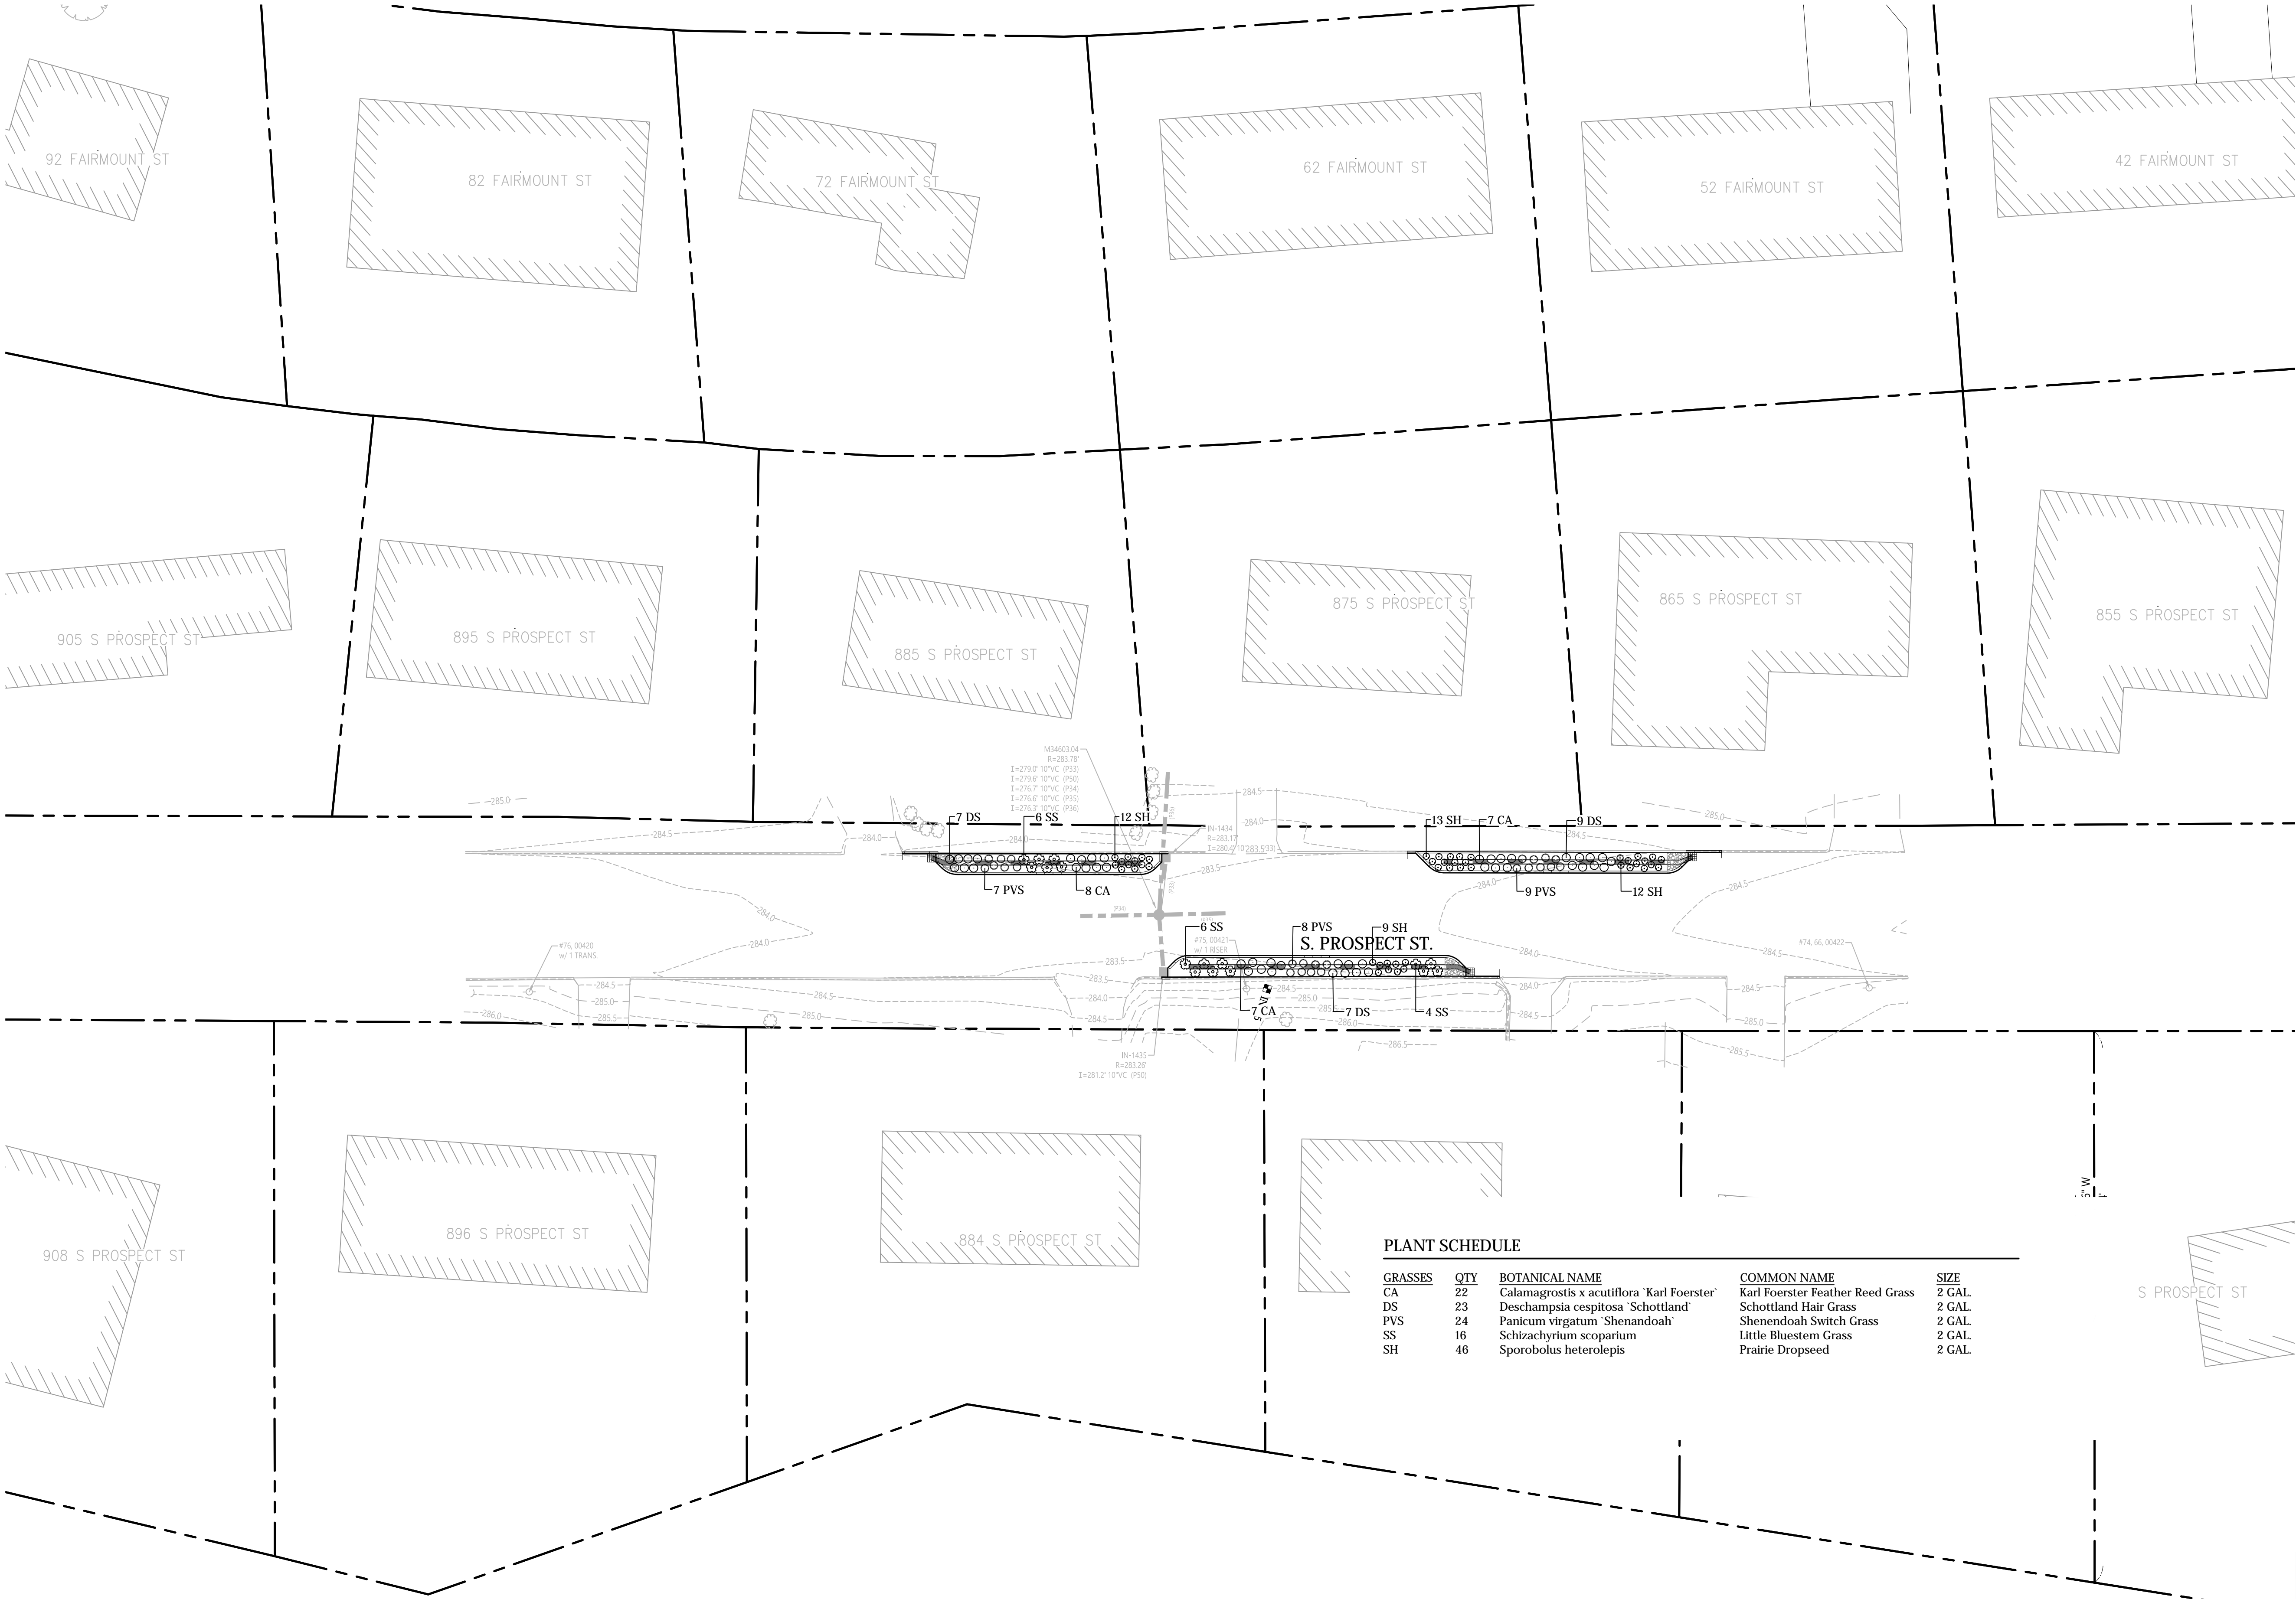


PLANT SCHEDULE

GRASSES	QTY	BOTANICAL NAME	COMMON NAME	SIZE
CA	22	Calamagrostis x acutiflora 'Karl Foerster'	Karl Foerster Feather Reed Grass	2 GAL.
DS	23	Deschampsia cespitosa 'Schottland'	Schottland Hair Grass	2 GAL.
PVS	24	Panicum virgatum 'Shenandoah'	Shenendoah Switch Grass	2 GAL.
SS	16	Schizachyrium scoparium	Little Bluestem Grass	2 GAL.
SH	46	Sporobolus heterolepis	Prairie Dropseed	2 GAL.



vhb.com

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South End Retrofits
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No.	Revision	Date	Appd.

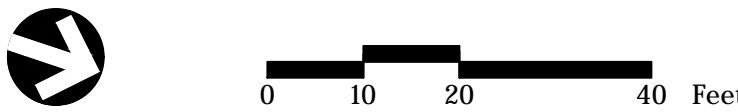Designed by
MKW


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MKW

Issued for
Bid

Date
Dec. 10, 2020


Drawing Title
Planting Plan

Drawing Number
L-1.02



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58126.01

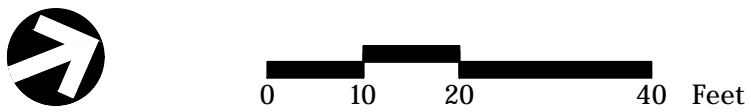

South End Retrofits

S. Prospect St. and Prospect Pky


Burlington, VT

No.	Revision	Date	Appd.

Designed by	MKW	Checked by	MKW
Issued for	Bid	Date	Dec. 10, 2020

Drawing Title

Planting Plan





Michael K. Wilbur

L-1.03

Sheet 22 of 24

Project Number 58126.01

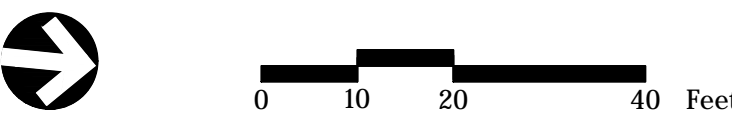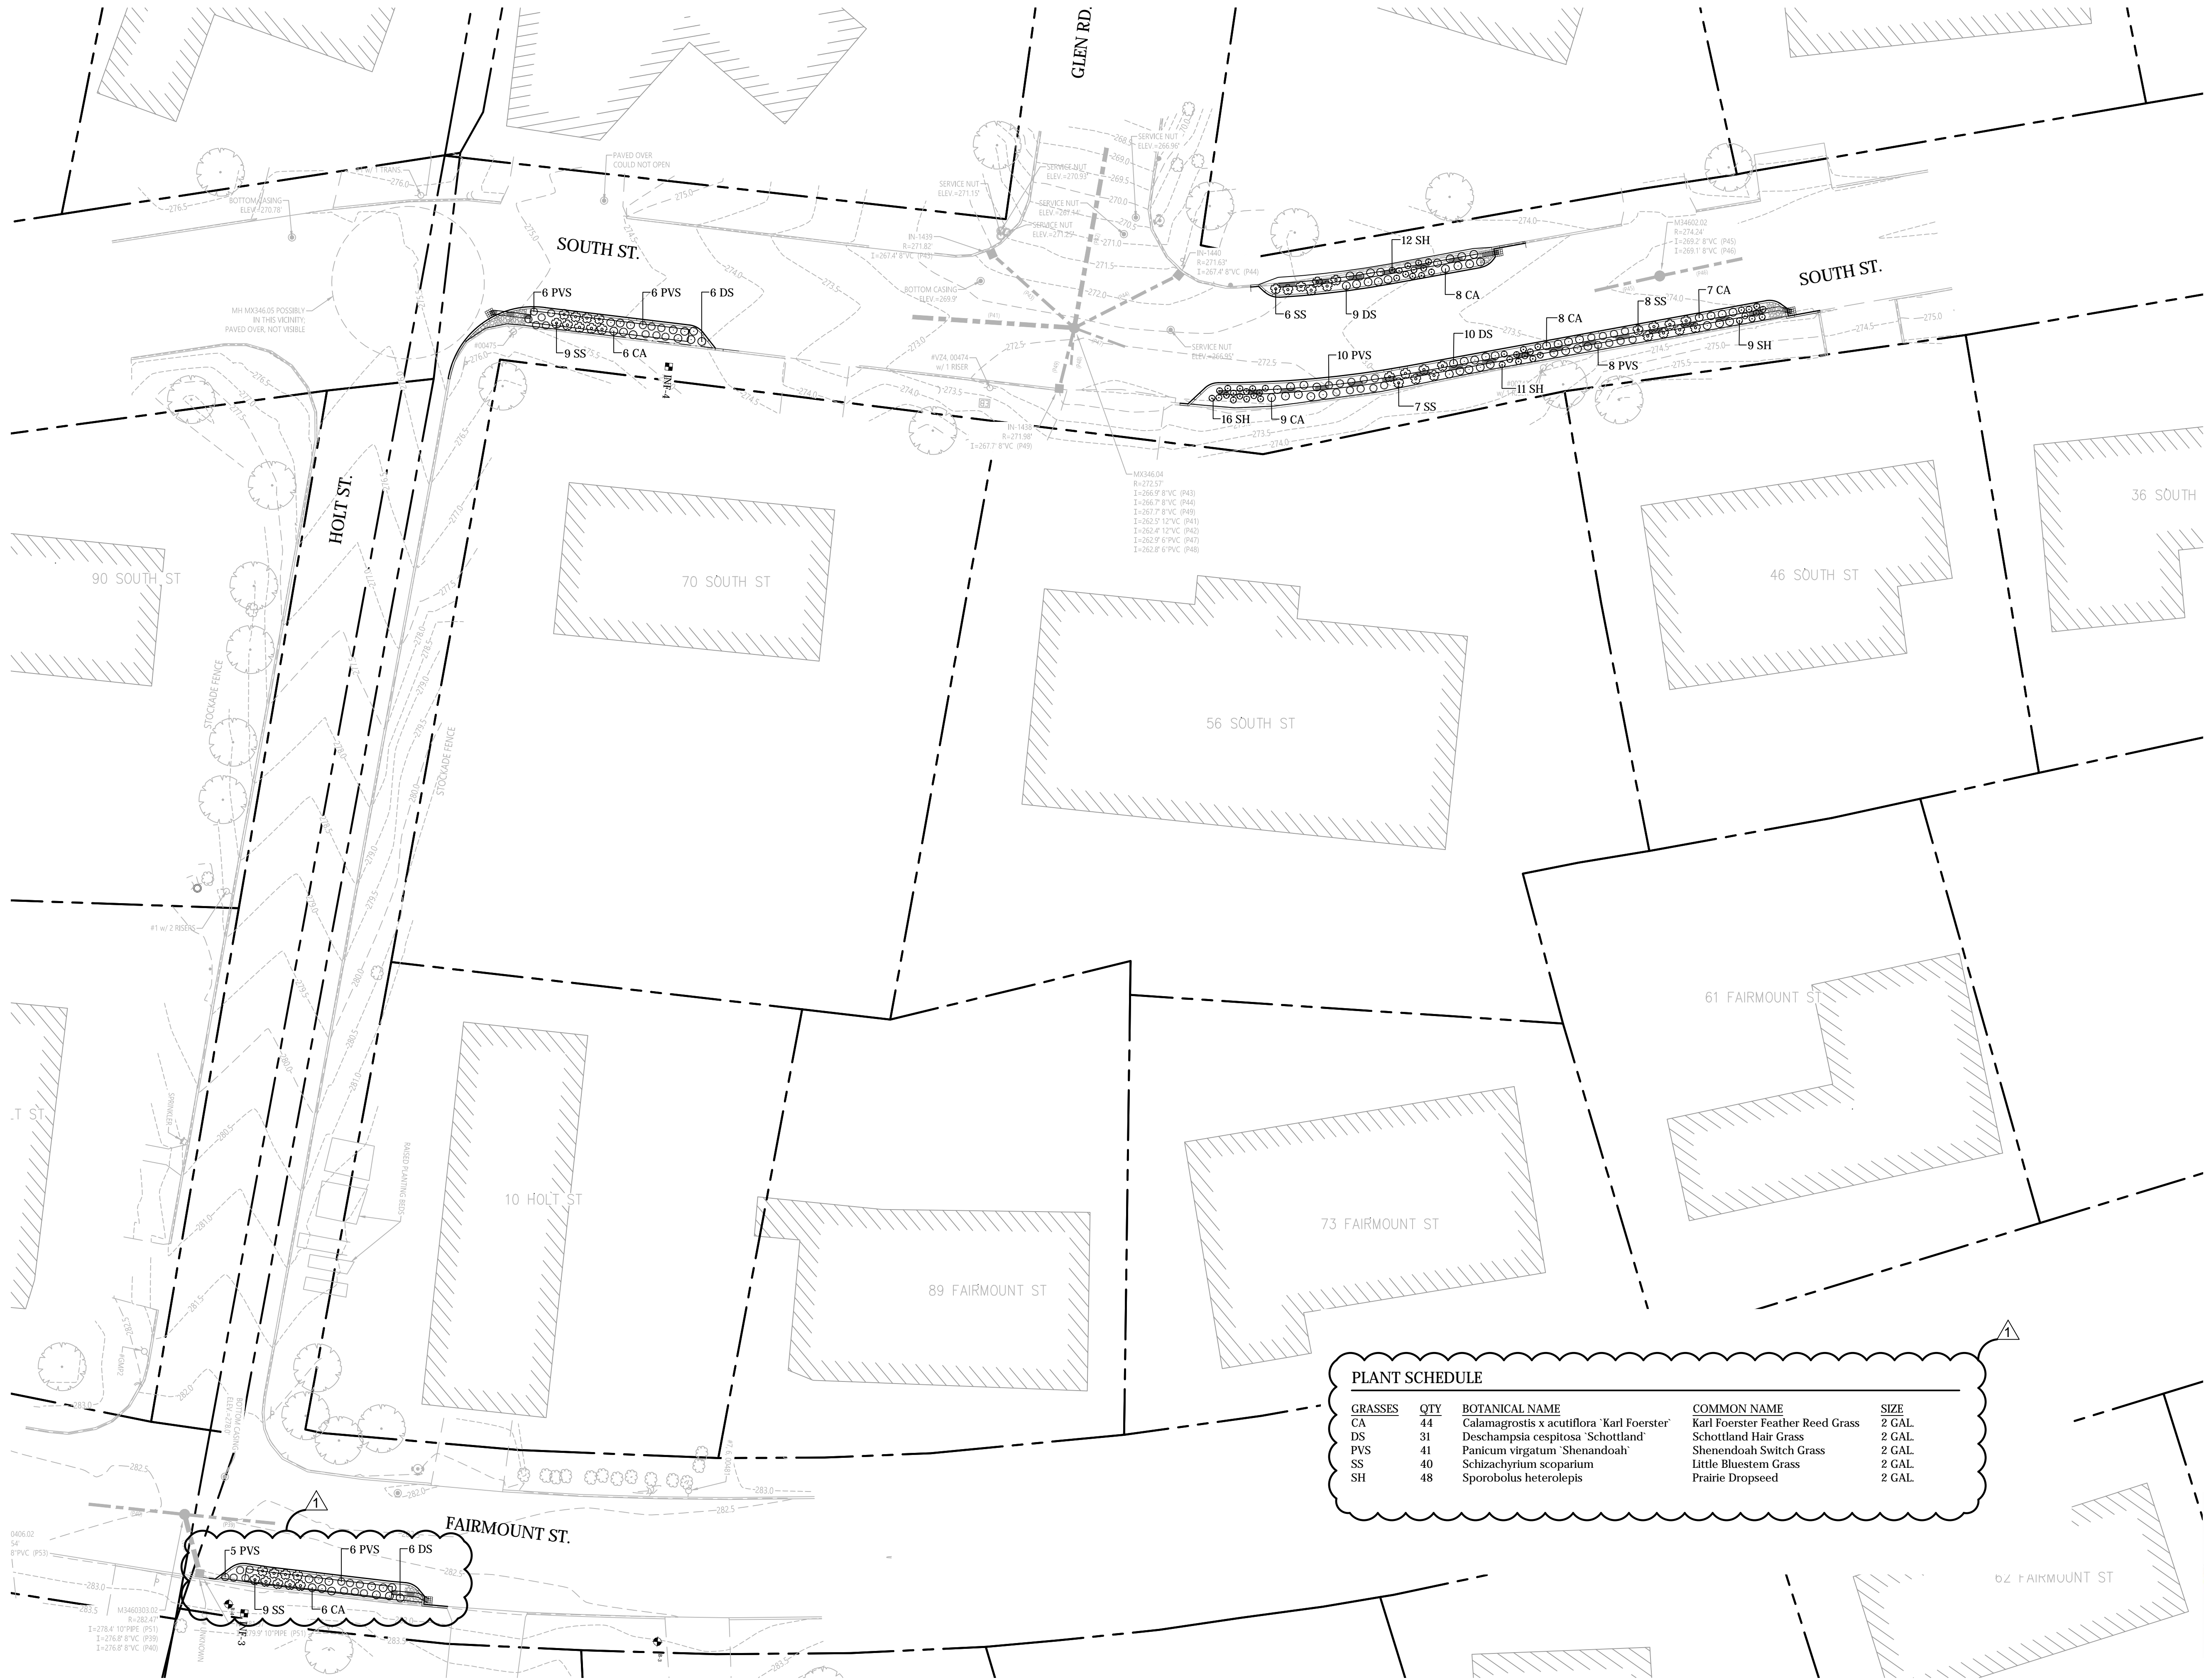

South End Retrofits
S. Prospect St. and Prospect Pky
Burlington, VT

No.	Revision	Date	Appd.
1	Planting Plan for ISP	1/04/21	NCH


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Issued for	Bid	Date	Dec. 10, 2020

Planting Plan


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Project Number: 58126.01




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B

PERENNIAL PLANTING

SCALE: 1/2" = 1'-0"

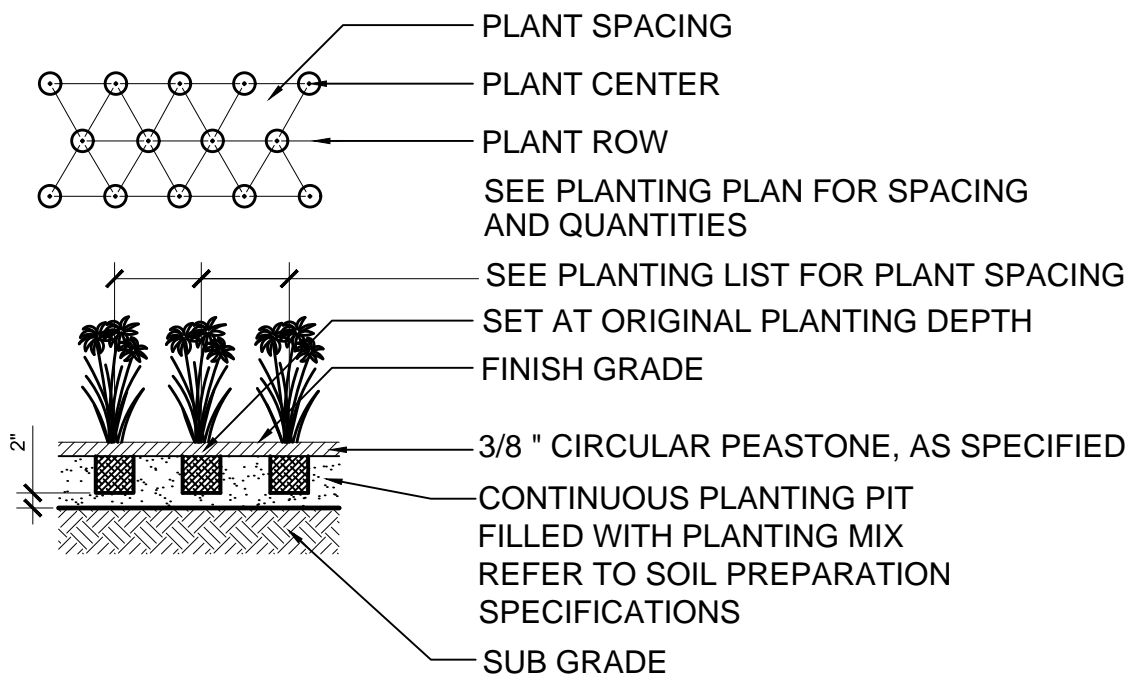

A

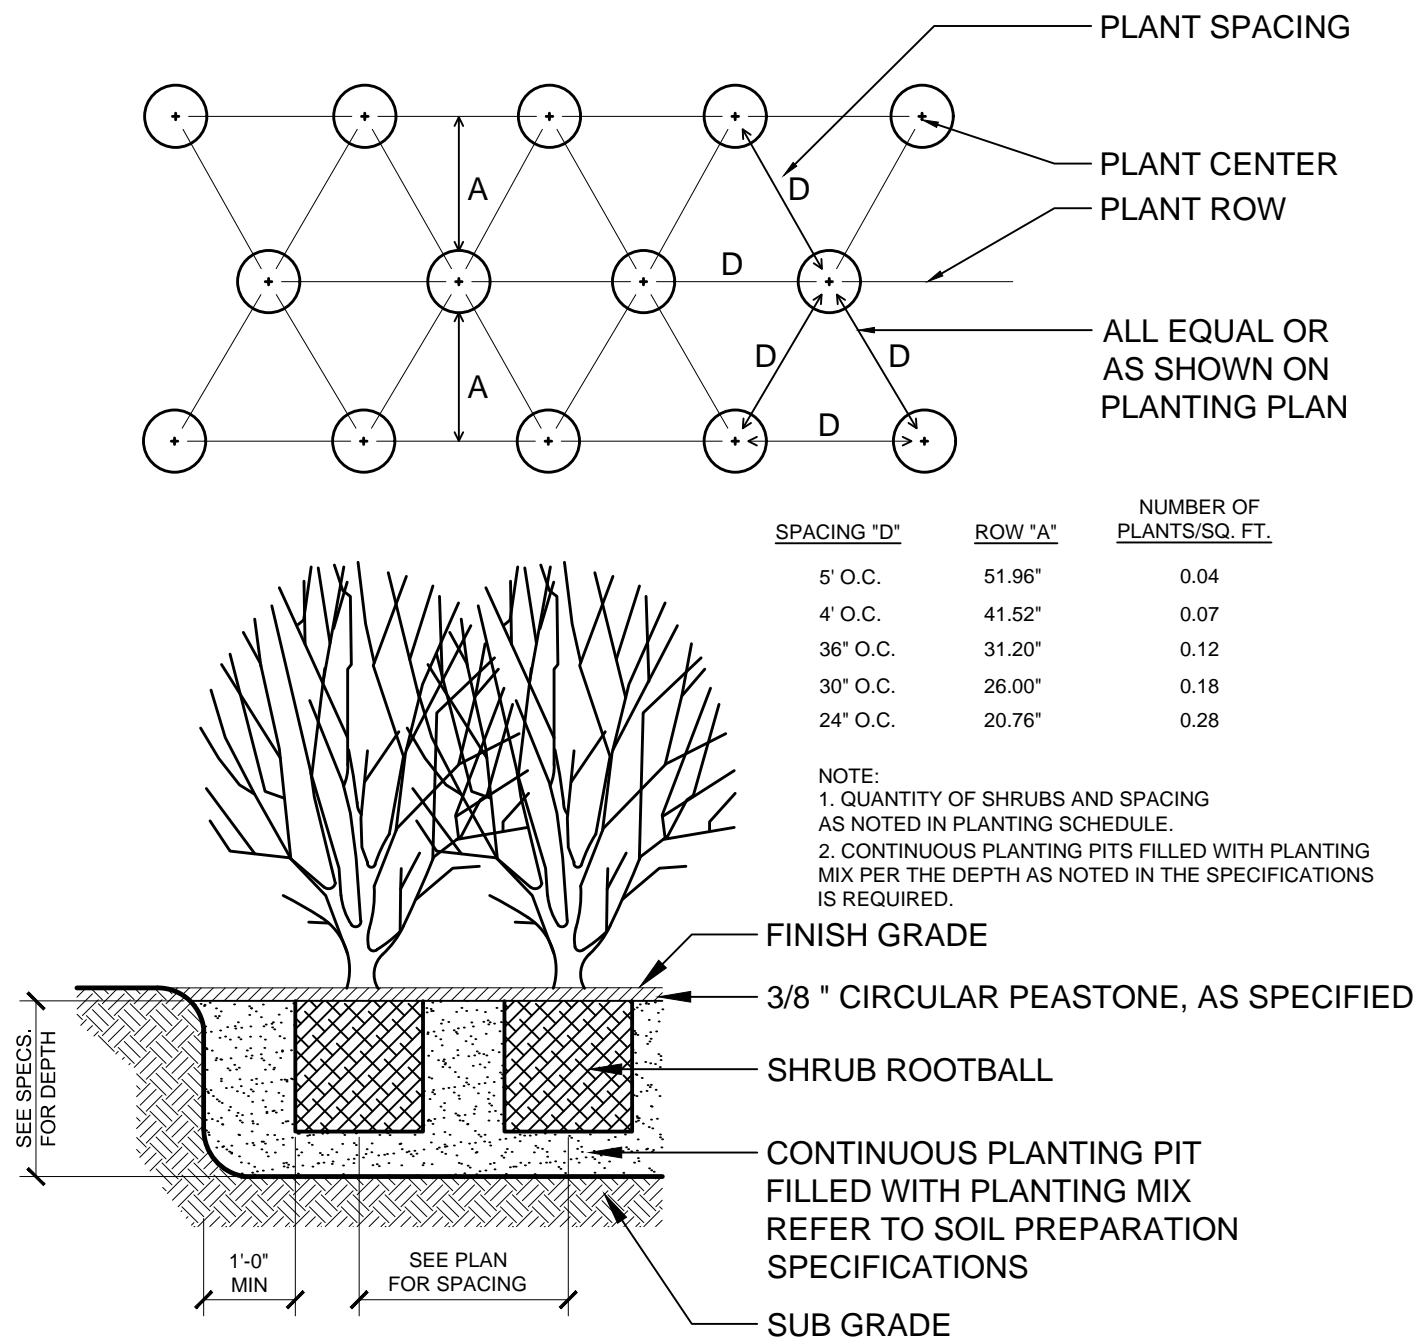SHRUB PLANTING

SCALE: 1/2" = 1'-0"


South End Retrofits

S. Prospect St. and Prospect Pky
Burlington, VT

No.	Revision	Date	Apprd.

Designed by	MKW	Checked by	MKW
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Issued for	Bid	Date	Dec. 10, 2020
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VERMONT
Michael K. Wilbur
10 DECEMBER 2020
No. 125.008321
REGISTERED LANDSCAPE ARCHITECT

L-2.00

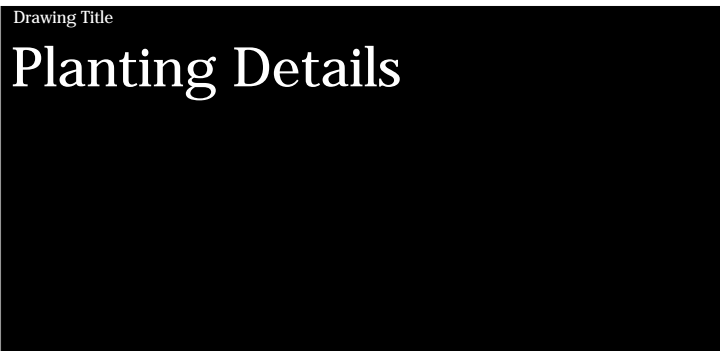Sheet 24 of 24

Project Number
58126.01